LOWERESIDENCE

SHEET INDEX:


COVER SHEET FOUNDATION PLAN S-102 SECOND FLOOR FRAMING & ROOF PLAN (SEE MFR DRAWINGS) UPPER LEVEL ROOF PLAN MAIN LEVEL SHEAR WALL PLAN S-104 S-105 SECOND LEVEL SHEAR WALL PLAN

CONCRETE DETAILS


A-101 ARCHITECTURAL SITE PLAN MAIN LEVEL FLOOR PLAN A-111

& DOOR/WINDOW SCHEDULES SECOND LEVEL FLOOR PLAN A-112 **BUILDING ELEVATIONS** A-201

BUILDING ELEVATIONS ARCHITECTURAL DETAILS

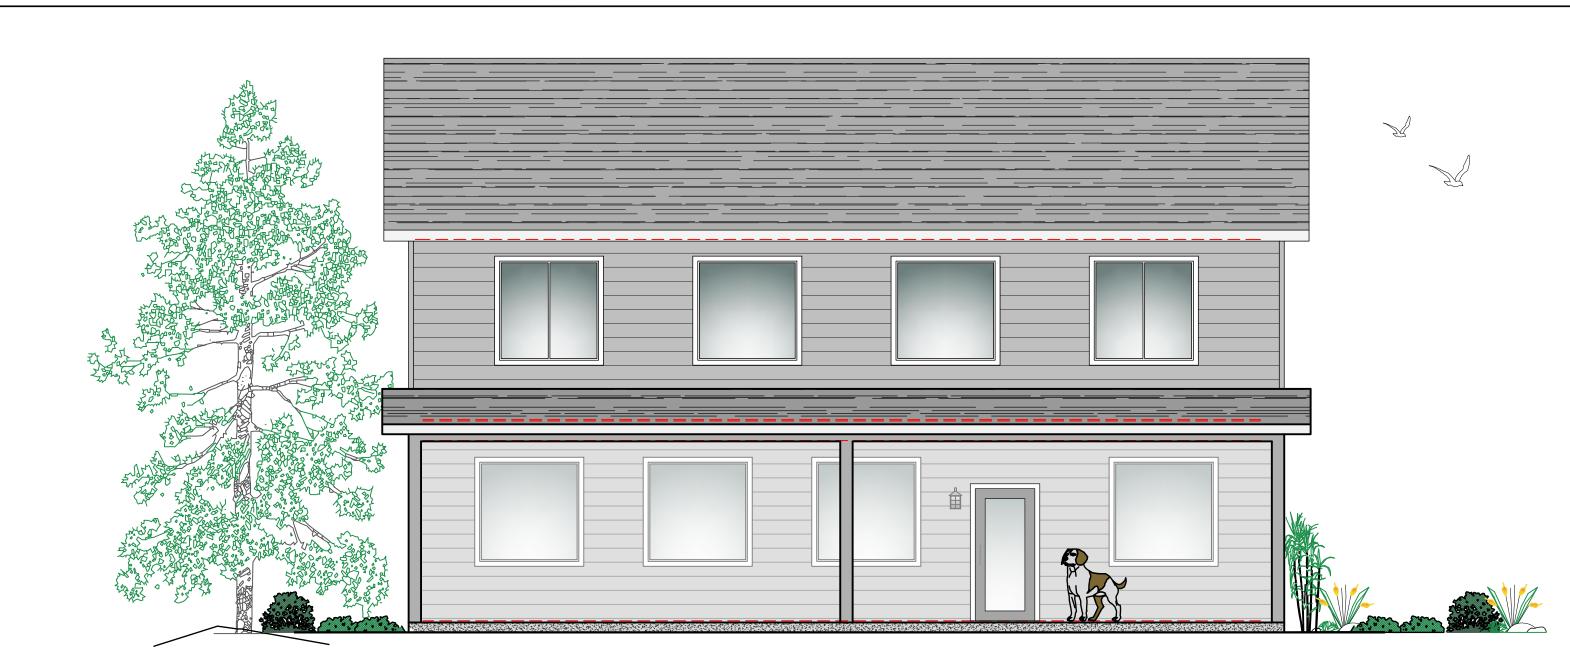

WALL TYPES:

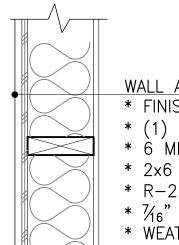

WALL ASSEMBLY:

* FINISH: PAINT PER OWNER * (1) LAYER OF 1/2" GWB OR EQUAL

* 6 MIL VAPOR BARRIER

* 2x6 WOOD STUD FRAMING @ 16" O.C * R-21 BATT INSULATION

* 7/6" OSB SHEATHING OR EQUAL

* WEATHER BARRIER * EXTERIOR FINISH: SEE ELEVATIONS


WALL ASSEMBLY: *FINISH: PAINT PER OWNER

* (1) LAYER OF ½" GWB OR EQUAL * 2x4 WOOD STUD WALL @ 16" O.C


* SOUND INSULATION (OPTIONAL)

* (1) LAYER OF 1/8" GWB OR EQUAL * FINISH: PAINT PER OWNER

2x6 FRAMING @ PLUMBING WALLS

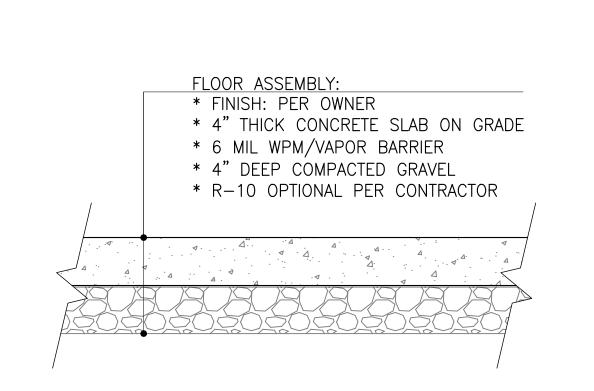

* 7/6" ROOF SHEATHING OR EQUAL * PRE-ENG. ROOF TRUSS SYSTEM PER ROOF TRUSS PROVIDER * R-49 INSULATION, MIN. * (1) LAYER OF %" GWB (OR APPROVED EQUAL) * FINISH: PAINT PER OWNER

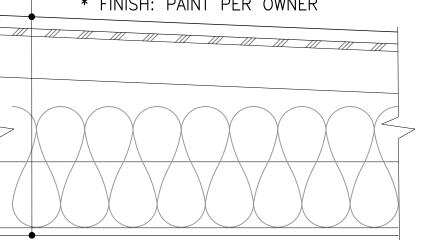

* ROOFING SYSTEM PER ELEVATIONS

* ROOFING FELT UNDERLAYMENT OR EQUAL

R-38 INSULATION @ VAULTED CEILINGS

A | EXTERIOR WALL ASSEMBLY

THE CONTRACTOR IS RESPONSIBLE TO CHECK THE PLANS & TO NOTIFY THE DESIGNER OF ANY ERRORS OR OMISSIONS PRIOR TO THE START OF CONSTRUCTION.

1 1/2"=1'

CONSTRUCTION, WORKMANSHIP, AND MATERIAL SHALL CONFORM TO: NOTES IN THIS SET OF CONSTRUCTION DOCUMENTS, ALL APPLICABLE LOCAL AND STATE CODES, CURRENT EDITION OF THE INTERNATIONAL RESIDENTIAL BUILDING CODE AND ALL OTHER

CODES AS LOCALLY ADOPTED AND AMENDED. IN THE EVENT OF CONFLICT BETWEEN PERTINENT CODES AND REGULATIONS AND REFERENCED STANDARDS OF THESE DRAWINGS, THE

MORE STRINGENT PROVISIONS SHALL GOVERN.

CONTRACTORS AND SUBCONTRACTORS SHALL VISIT THE SITE PRIOR TO BIDDING AND SHALL VERIFY ALL JOB SITE CONDITIONS AND DIMENSIONS, REPORT TO THE DESIGNER IN WRITING ANY DISCREPANCIES BETWEEN ON-SITE CONDITIONS AND THE CONSTRUCTION DOCUMENTS (INCLUDING SPECIFICATIONS) PRIOR TO PROCEEDING WITH THE AFFECTED PORTION OF THE WORK

UNDER NO CIRCUMSTANCES SHALL ANY SHEETS (DRAWINGS, PRINTS, PLANS, ETC) MARKED 'PRELIMINARY', 'BID SET', OR 'PROGRESS PRINTS' BE USED FOR ACTUAL CONSTRUCTION. GENERAL CONTRACTOR SHALL PROVIDE SUBCONTRACTORS WITH MARKED LATEST

APPROVALS BY BUILDING INSPECTOR SHALL NOT CONSTITUTE AUTHORITY TO DEVIATE FROM PLANS AND SPECIFICATIONS

OMISSIONS: IN THE EVENT CERTAIN FEATURES OF THE CONSTRUCTION ARE NOT FULLY SHOWN ON THE DRAWINGS, THEIR CONSTRUCTION SHALL BE OF THE SAME CHARACTER AS SIMILAR CONDITIONS THAT ARE SHOWN. IF FEATURES ARE STILL UNCLEAR, CONTACT THE DESIGNER FOR CLARIFICATION.

THE CONTRACTOR SHALL PROVIDE QUALIFIED PERSONNEL THROUGHOUT THE WORK. THE CONTRACTOR IS RESPONSIBLE TO SEE THAT WORK IN THE FIELD IS DONE IN ACCORDANCE WITH ALL CURRENT APPLICABLE NATIONAL, STATE AND LOCAL CODES, ORDINANCES, REQUIREMENTS, ETC. ARE SPECIFICALLY SHOWN ON DRAWINGS AND/OR CALLED FOR IN THE SPECIFICATIONS. ALL MANUFACTURED MATERIALS, COMPONENTS, FASTENERS, ASSEMBLIES, ETC, SHALL BE HANDLED AND INSTALLED IN ACCORDANCE

WITH MANUFACTURER'S INSTRUCTIONS AND PROVISIONS OF APPLICABLE ICBO RESEARCH RECOMMENDATIONS. WHERE SPECIFIC MANUFACTURED PRODUCTS ARE CALLED FOR, PRODUCTS OF EQUAL QUALITY WHICH MEET APPLICABLE STANDARDS AND SPECIFICATIONS MAY BE USED, BUT ONLY IF APPROVED BY THE DESIGNER UNLESS SPECIFICALLY NOTED IN THE CONTRACT, DESIGNER(S) WILL NOT BE OBSERVING THE CONSTRUCTION OF THIS PROJECT. THE CONTRACTOR IS SOLELY RESPONSIBLE FOR FINAL DIMENSIONS, QUANTITIES, COORDINATION OF THE WORK OF ALL TRADES, QUALITY CONTROL, AND CONSTRUCTION STANDARDS FOR

SHOP DRAWINGS AND OTHER SUBMITTALS PREPARED BY CONTRACTORS IN CONNECTION WITH SOME PORTION OF THIS WORK ARE TO BE SUBMITTED TO THE DESIGNER AND APPROVED PRIOR TO COMMENCEMENT OF ORDERING FABRICATION, CONSTRUCTION, OR

CONTRACTOR SHALL CONSULT, PRIOR TO THE START OF CONSTRUCTION, REPRESENTATIVES OF CITY AND GAS (OIL), ELECTRIC, WATER, TELEPHONE, AND CABLE COMPANIES CONCERNING UTILITIES AVAILABILITY AND HOOK-UP, AS WELL AS CALL FOR LOCATIONS THE CONTRACTOR SHALL ASSUME SOLE AND COMPLETE RESPONSIBILITY FOR THE JOB SITE CONDITIONS DURING CONSTRUCTION OF

WORKING HOURS. THE CONTRACTOR SHALL DEFEND, INDEMNIFY, AND HOLD THE OWNER AND THE ARCHITECT HARMLESS FROM ANY AND ALL LIABILITY, REAL OR ALLEGED, IN CONNECTION WITH THE PROJECT, EXCEPT FOR LIABILITY ARISING FROM THE SOLE NEGLIGENCE OF THE OWNER OR ARCHITECT THE OWNER AND ARCHITECT SHALL BE NAMED AS ADDITIONS INSURED ON THE

THE PROJECT INCLUDING THE SAFETY OF ALL PERSONS AND PROPERTY CONTINUOUSLY DURING, BUT NOT LIMITED TO, NORMAL

CONTRACTOR'S LIABILITY INSURANCE COVERAGE. 13 WRITTEN DIMENSIONS HAVE PRECEDENCE OVER SCALED DIMENSIONS. DO NOT SCALE THE DRAWINGS.

REGULAR CEILINGS: R-49 VAULTED CEILINGS: R-38 CRAWLSPACE/FLOORS R-30 2x6 WALLS R-21 2x4 WALLS IR-13 FOUNDATION/SLAB R-10

THE ABOVE VALUES ARE A MINIMUM AND MAY BE INCREASED IF DESIRED ALL EXPOSED INSULATION IS TO HAVE A FLAME SPREAD RATING OF LESS THAN 25 AND A SMOKE DENSITY RATING

OF LESS THAN 450. COVER ANY FOAM INSULATION WITH ONE—HALF INCH THICK GYPSUM BOARD OR PLYWOOD. 16 ALL CONCRETE SLABS SHALL HAVE CONTROL JOINTS AS REQUIRED.

17 CONCRETE SIDEWALKS TO HAVE 3/4" TOOLED JOINTS AT 5' O.C. (MINIMUM).

18 EXCAVATE THE SITE TO PROVIDE MINIMUM OF 18" CLEARANCE UNDER ALL GIRDERS & JOISTS.

B INTERIOR WALL ASSEMBLY C | FLOOR ASSEMBLY 1 1/2"=1' COVER ENTIRE CRAWL SPACE WITH 6-MIL POLYETHYLENE. LAP PERIMETER FOOTINGS 12 INCHES. LAP ALL SEAMS 12 INCHES. POLYETHYLENE TO EXTEND TO BOTTOM EDGE OF SUB-FLOOR. SEAL WITH "TEMCO" SEALANT (OR EQUAL).

> PROVIDE A MINIMUM OF TWO 8" X 16" DAMPERED VENTS INTO THE CRAWL SPACE AREA. VENTS ARE TO BE 20 CLOSEABLE WITH 1/4" OPENING COVERED BY CORROSIVE RESISTANT SCREEN. SEE FOUNDATION PLAN FOR SPECIFIC CODE NOTES AND CALCULATION OF VENTS.

21 ALL WOOD IN CONTACT WITH CONCRETE OR MASONRY TO BE PRESSURE-PRESERVATIVE-TREATED.

22 | ALL EXTERIOR OPENINGS & BEARING WALL OPENINGS TO BE PER ROOF PLAN OR OTHERWISE NOTED ON THE PLANS. JOISTS THAT ARE ATTACHED TO FLUSH BEAMS ARE TO BE HUNG WITH SIMPSON JOIST HANGER THAT MATCHES JOIST

23 SIZE. (OR APPROVED EQUAL) 24 PROVIDE DOUBLE JOISTS UNDER ALL PARALLEL PARTITIONS.

25 PROVIDE FIREBLOCKING, DRAFTSTOPS, & FIRESTOPS AS PER THE I.R.C.

EACH BEDROOM TO HAVE A MINIMUM EGRESS WINDOW OPENING OF 5.7 SQ. FT. WITH A MIN. WIDTH OF 20", MINIMUM

HEIGHT OF 24", & A SILL LESS THAN 44" OFF THE FLOOR. ALL WINDOWS WITHIN 18" OF THE FLOOR OR WALKING SURFACES WITHIN 24" OF ANY DOOR, OR 9 S.F., ARE TO HAVE

SKYLIGHTS ARE TO BE GLAZED WITH TEMPERED GLASS ON OUTSIDE & LAMINATED GLASS ON INSIDE (UNLESS PLEXIGLASS). GLASS TO HAVE MAXIMUM CLEAR SPAN OF 25". SKYLIGHT FRAME IS TO BE ATTACHED TO A 2X CURB WITH A MINIMUM OF 4" ABOVE ROOF PLANE. FRAME TO BE COVERED WITH ICE & WATER SHIELD WHICH SHALL

EXTEND 24" ONTO THE ROOF SHEATHING. 29 | IF TUB OR SHOWER HAS AN ENCLOSURE SAFETY GLAZING IS REQUIRED.

ALL EXTERIOR WINDOWS ARE TO BE DOUBLE INSULATED GLASS & ALL EXTERIOR DOORS ARE TO BE SOLID CORE | WOOD OR INSULATED METAL WITH WEATHERSTRIPPING. PROVIDE 1/2" DEADBOLT LOCKS ON ALL EXTERIOR DOORS & LOCKING DEVICES ON ALL DOORS OR WINDOWS WITHIN 10' (VERTICAL) OF GRADE. PROVIDE PEEP-HOLE 54" - 66"

ABOVE DOOR FLOOR ON EXTERIOR DOORS. PROVIDE SMOKE DETECTORS ON ALL LEVELS, IN EVERY SLEEPING ROOM & ADJACENT HALLWAYS WIRED IN SERIES

CONNECT ALL SMOKE DETECTORS (SEE PLAN FOR APPROXIMATE LOCATION) TO HOUSE ELECTRICAL SYSTEM & 32 INTERCONNECT EACH ONE SO THAT WHEN ANY ONE IS TRIPPED THEY WILL ALL SOUND. SMOKE DETECTORS TO HAVE

| ALL OUTLETS IN BATHROOM & GARAGE, ACCESSIBLE TO EXTERIOR GRADE (INCLUDING HEADBOLT HEATER OUTLETS) WITHIN 6 FEET OF SINKS & NEAR JETTED TUBS SHALL BE GFCI PROTECTED. PROVIDE COMBUSTION AIR VENTS (W/SCREEN) FOR FIREPLACES, WOOD STOVES & ANY APPLIANCES WITH AN OPEN

FLAME PER MANUFACTURER'S SPECIFICATIONS. |BATHROOMS & UTILITY (LAUNDRY) ROOMS ARE TO BE VENTED TO THE OUTSIDE WITH A MINIMUM OF A 100 CFM FAN RANGE HOODS ARE ALSO TO VENTED TO OUTSIDE. SCREW ALL DUCTWORK TOGETHER & SEAL WITH DUCT TAPE OR

SILICONE SEALANT. USE 3 SCREWS AT EACH JOINT. EXHAUST FROM DRYER SHALL BE VENTED TO EXTERIOR WITH DUCT WORK AS DESCRIBED ABOVE, BUT USE POP-RIVETS INSTEAD OF SCREWS.

PROVIDE 2 INCHES OF CLEAR VENT SPACE WITH APPROVED INSULATION BAFFLES AT EAVE VENTS BETWEEN RAFTERS OR TRUSSES. ATTACH PER MANUFACTURERS SPECIFICATIONS & REQUIRED WIND LOAD.

37 ALL TRUSSES TO HAVE 12 INCH DEEP ENERGY HEEL (MINIMUM). STRAP WATER HEATERS TO WALL. INSTALL BLOCKING BETWEEN STUDS TO ACCEPT BOLT FROM STRAP. CLIP BLOCKING

TO STUDS WITH SIMPSON L30 REINFORCING ANGLES. PROVIDE COMBUSTIBLE AIR PER REQUIRED CODES. |DOOR BETWEEN GARAGE & LIVING AREAS TO BE 1-3/8 INCHES THICK, SOLID CORE WITH AT LEAST 2 SELF-CLOSING HINGES & WEATHER-STRIPPING, 20 MINUTE RATING.

NO BREAKS BEHIND ALL PLATFORMS, STAIRS, ETC. ALL GAS FIRED APPLIANCES IN GARAGE OR ADJACENT SPACES SHALL BE LOCATED 18 INCHES ABOVE THE GARAGE FLOOR. PROVIDE ADEQUATE COMBUSTION AIR PER MFR. SPECIFICATIONS & REQUIRED CODES.

GYPSUM BOARD WALL COVERING IN GARAGE MUST EXTEND TO MASONRY FOUNDATION WALL OR CONCRETE SLAB WITH

D | ROOF TRUSS ASSEMBLY

1 1/2"=1'

THE SOILS REPORT FOR THE SITE INDICATED SHALLOW WATER, FOUNDATION IN AREA OF GROUND WATER SHALL E 42 WATER PROOFED. IN ADDITION, A PERIMETER FOUNDATION DRAIN SYSTEM MUST BE INSTALLED. THE SYSTEM DRAIN SHOULD EITHER DAYLIGHT AT A SIDE SLOPE OR RUN TO A SUMP WITH A SUMP PUMP. GYPSUM BOARD USED FOR GARAGE WALLS & CEILINGS SHALL BE 5/8" THICK TYPE "X". ALL SHOULD BE FIRE TAPED

ROOF ASSEMBLY:

44 | ELECTRIC CONDUCTORS IN UNFINISHED AREAS MUST BE PHYSICALLY PROTECTED. 45 ALL EXPOSED WOOD ON THE EXTERIOR OF THE HOUSE SHALL BE PROTECTED OR BE OF TREATED MATERIAL. 46 BACKING FOR TILE ON EXTERIOR WALLS SHALL BE WATER RESISTANT GYPSUM BOARD.

47 | DEDICATED CIRCUITS, ONE FOR THE DISHWASHER & THE OTHER FOR THE GARBAGE COMPACTOR. LOCATE A DUPLEX OUTLET BEHIND THE STOVE & REFRIGERATOR.

48 ALL EXTERIOR FAUCETS TO BE FROST-FREE WITH ANTI-SIPHON DEVICE. PROVIDE A CRICKET ON THE UPSLOPE OF A FLUE HOUSING. THE CRICKET SHALL BE CONSTRUCTED OF 2X FRAMING & SHEATHING & SHALL ALLOW FOR NO DRAINAGE TO IMPACT HOUSING.

50 ALL GROOVED 303 SIDING (TI-11) SHALL BE APPLIED WITH GROOVES VERTICAL ONLY. (IF USED)

51 ALL EXTERIOR WALLS TO BE 2" X 6" @ 16" O.C. EXCEPT WHERE INDICATED 52 ALL INTERIOR WALLS TO BE 2" X 4" @ 16" O.C. EXCEPT WHERE INDICATED.

53 ALL CHASES TO BE OF 1-HR. CONSTRUCTION PER I.R.C.

|HEADROOM CLEARANCE AT STAIRWAYS SHOULD BE A MINIMUM OF 6'-8" MEASURED VERTICALLY FROM THE SLOPED 54 |LINE ADJOINING THE TREAD NOSING OR FROM THE FLOOR SURFACE OF THE LANDING OR PLATFORM ON THAT PORTION OF THE STAIRWAY PER I.R.C.

55 | 25" R.O. FOR CLOTHING CLOSET DEPTHS (MIN.)

56 ALL ELECTRICAL WORK TO COMPLY WITH STATE & MUNICIPAL CODES AS ADOPTED.

57 | ALL OUTLETS IN BATHROOMS ARE G.F.C.I.'S HANDRAILS SHALL HAVE A MAXIMUM HEIGHT OF 38" & A MINIMUM HEIGHT OF 34", MEASURED VERTICALLY FROM THE NOSING OF THE TREADS, SHALL BE PROVIDED ON AT LEAST ONE SIDE OF STAIRWAYS OF FOUR OR MORE RISERS & SHALL BE CONTINUOUS THE FULL LENGTH OF THE FLIGHT & SHALL EXTEND 6 INCHES BEYOND THE TOP & BOTTOM

RISERS. ENDS SHALL BE RETURNED OR SHALL TERMINATE IN NEWEL POSTS OR SAFETY TERMINALS. OPEN SIDES OF STAIRS WITH A TOTAL RISE OF MORE THAN 30 INCHES ABOVE THE FLOOR OR GRADE BELOW SHOULD HAVE GUARDRAILS.

THE HANDGRIP PORTION OF THE HANDRAILS SHALL BE NOT LESS THAN 1 1/4 INCHES BUT NOT MORE THAN 2 60 |INCHES IN CROSS-SECTIONAL DIMENSIONS, OR THE SHAPE SHALL PROVIDE AN EQUIVALENT GRIPPING SURFACE. THE HANDGRIP PORTION OF HANDRAILS SHALL HAVE A SMOOTH SURFACE WITH NO SHARP CORNERS.

|HANDRAILS PROJECTING FROM A WALL SHALL HAVE A SPACE OF NOT LESS THAN 1-1/2 INCHES BETWEEN THE WALL PORCHES, BALCONIES OR RAISED FLOOR SURFACES LOCATED LESS THAN 5'-10" ABOVE THE FLOOR OR GRADE BELOW

SHALL HAVE GUARDRAILS WITH A MAXIMUM HEIGHT OF 38" & A MINIMUM HEIGHT OF 34". PORCHES, BALCONIES OR RAISED FLOOR SURFACES LOCATED MORE THAN 5'-10" ABOVE THE FLOOR OR GRADE BELOW SHALL HAVE GUARDRAILS WITH A MAXIMUM HEIGHT OF 47" & A MINIMUM HEIGHT OF 42".

REQUIRED GUARDRAILS ON OPEN SIDES OF STAIRWAYS, RAISED FLOOR AREAS, BALCONIES & PORCHES SHALL HAVE 64 INTERMEDIATE RAILS OR ORNAMENTAL CLOSURES WHICH WILL NOT ALLOW PASSAGE OF A SPHERE 4 INCHES OR MORE

FRAMING CONTRACTOR IS RESPONSIBLE FOR FIELD LOCATING ALL-THREAD & HOLDOWNS WITH BRIGHT ORANGE PAINT PRIOR TO GROUTING STEM WALL. IF ALL—THREAD EXTENDS INTO FOOTING, THE SAME APPLIES.

CL CENTER LINE CLG CEILING CONC CONCRETE CONST CONSTRUCTION CONT CONTINUOUS CMU CONCRETE MASONRY UNIT DIA | DIAMETER DIM DIMENSION DN DOWN DW DISH WASHER

EA LEACH (E) EXISTING EF EXHAUST FAN EXT EXTERIOR

ABBREVIATIONS:

A/C AIR CONDITIONING

ALT ALTERNATE

ASSEM | ASSEMBLY

BSMT BASEMENT

BM BEAM

ARCH | ARCHITECTURAL

ELEV | ELEVATIONS EQUIP | EQUIPMENT FTG FOOTING

GA GAUGE OR GAGE GALV GALVANIZED GFI GROUND FAULT INTERRUPTER

GLB GLUE LAMINATED BEAM

GWB GYPSUM WALL BOARD HORIZ HORIZONTAL HT HEIGHT

HVAC | HEATING VENTILATION & AIR CONDITIONING INSUL INSULATION

INT INTERIOR MFR MANUFACTURER MIN MINIMUM

MISC MISCELLANEOUS

n Inorth NTS NOT TO SCALE OC ON CENTER

OHD OVERHEAD DOOR OSB ORIENTED STRAND BOARD

PLYWD |PLYWOOD PT PRESSURE TREATED FOR RESISTANCE TO WATER DECAY

R |RADIUS REFR | REFRIGERATOR

REQ | REQUIRED RO | ROUGH OPENING R/S | ROUGH SAWN

SHR | SHEAR 1 1/2"=1' SHWR ISHOWER SF | SQUARE FEET

SIM |SIMILAR SQ FT SQUARE FEET STRUC |STRUCTURAL

TYP TYPICAL UNO JUNLESS NOTED OTHERWISE TWO DEDICATED 20 AMP APPLIANCE CIRCUITS ARE REQUIRED ABOVE THE KITCHEN COUNTER TOP. TWO ADDITIONAL

VERT VERTICAL

MILENKO@DRAFTCODESIGNS.COM

WEB: DRAFTCODESIGNS.COM

4/11/2023 9:38:42 AM

509.251.5939

BUILDING INFO: MAIN LEVEL SECOND LEVEL GARAGE COVERED ENTRY 264 LIVING SPACE NON-LIVING SPACE TOTAL SCOPE

HOME MOL \mathcal{O}

> **COPYRIGHT NOTICE:** USE OF THESE PLANS WITHOUT EXPLICIT PERMISSION OF DRAFTCO DESIGNS LLC AND PAYMENT IS A COPYRIGHT VIOLATION WHICH MAY SUBJECT THE USER TO LIABILITY UNDER BOTH STATE AND FEDERAL LAW. THE BUILDER/OWNER IS LICENSED A ONE-TIME USE OF THESE

PLANS. ALL PLANS ARE SITE SPECIFIC.

COVER SHEET

ATTENTION

PROPERTY REGULATIONS:


NOT INCLUDED IN A DRAWING SET, PLEASE WORK WITH OWNER AND

SEE HOA PROPERTY REGULATIONS AND STRICTLY FOLLOW CC&R.

GET THE INFORMATION PROVIDED TO YOU

SHEET NO. WHERE APPLICABLE; STRUCTURAL ENGINEERED PLANS SHALL SUPERCEDE ANY/ALL INFORMATION HEREIN THE ARCHITECTURAL DESIGN SET INCLUDING BUT NOT LIMITED TO ASSEMBLIES AND/OR ARCHITECTURAL DETAILS (CONTRACTOR TO VERIFY ANY AND ALL ASPECTS OF DESIGN PRIOR TO START OF CONSTRUCTION)

GENERAL CONSTRUCTION NOTES:

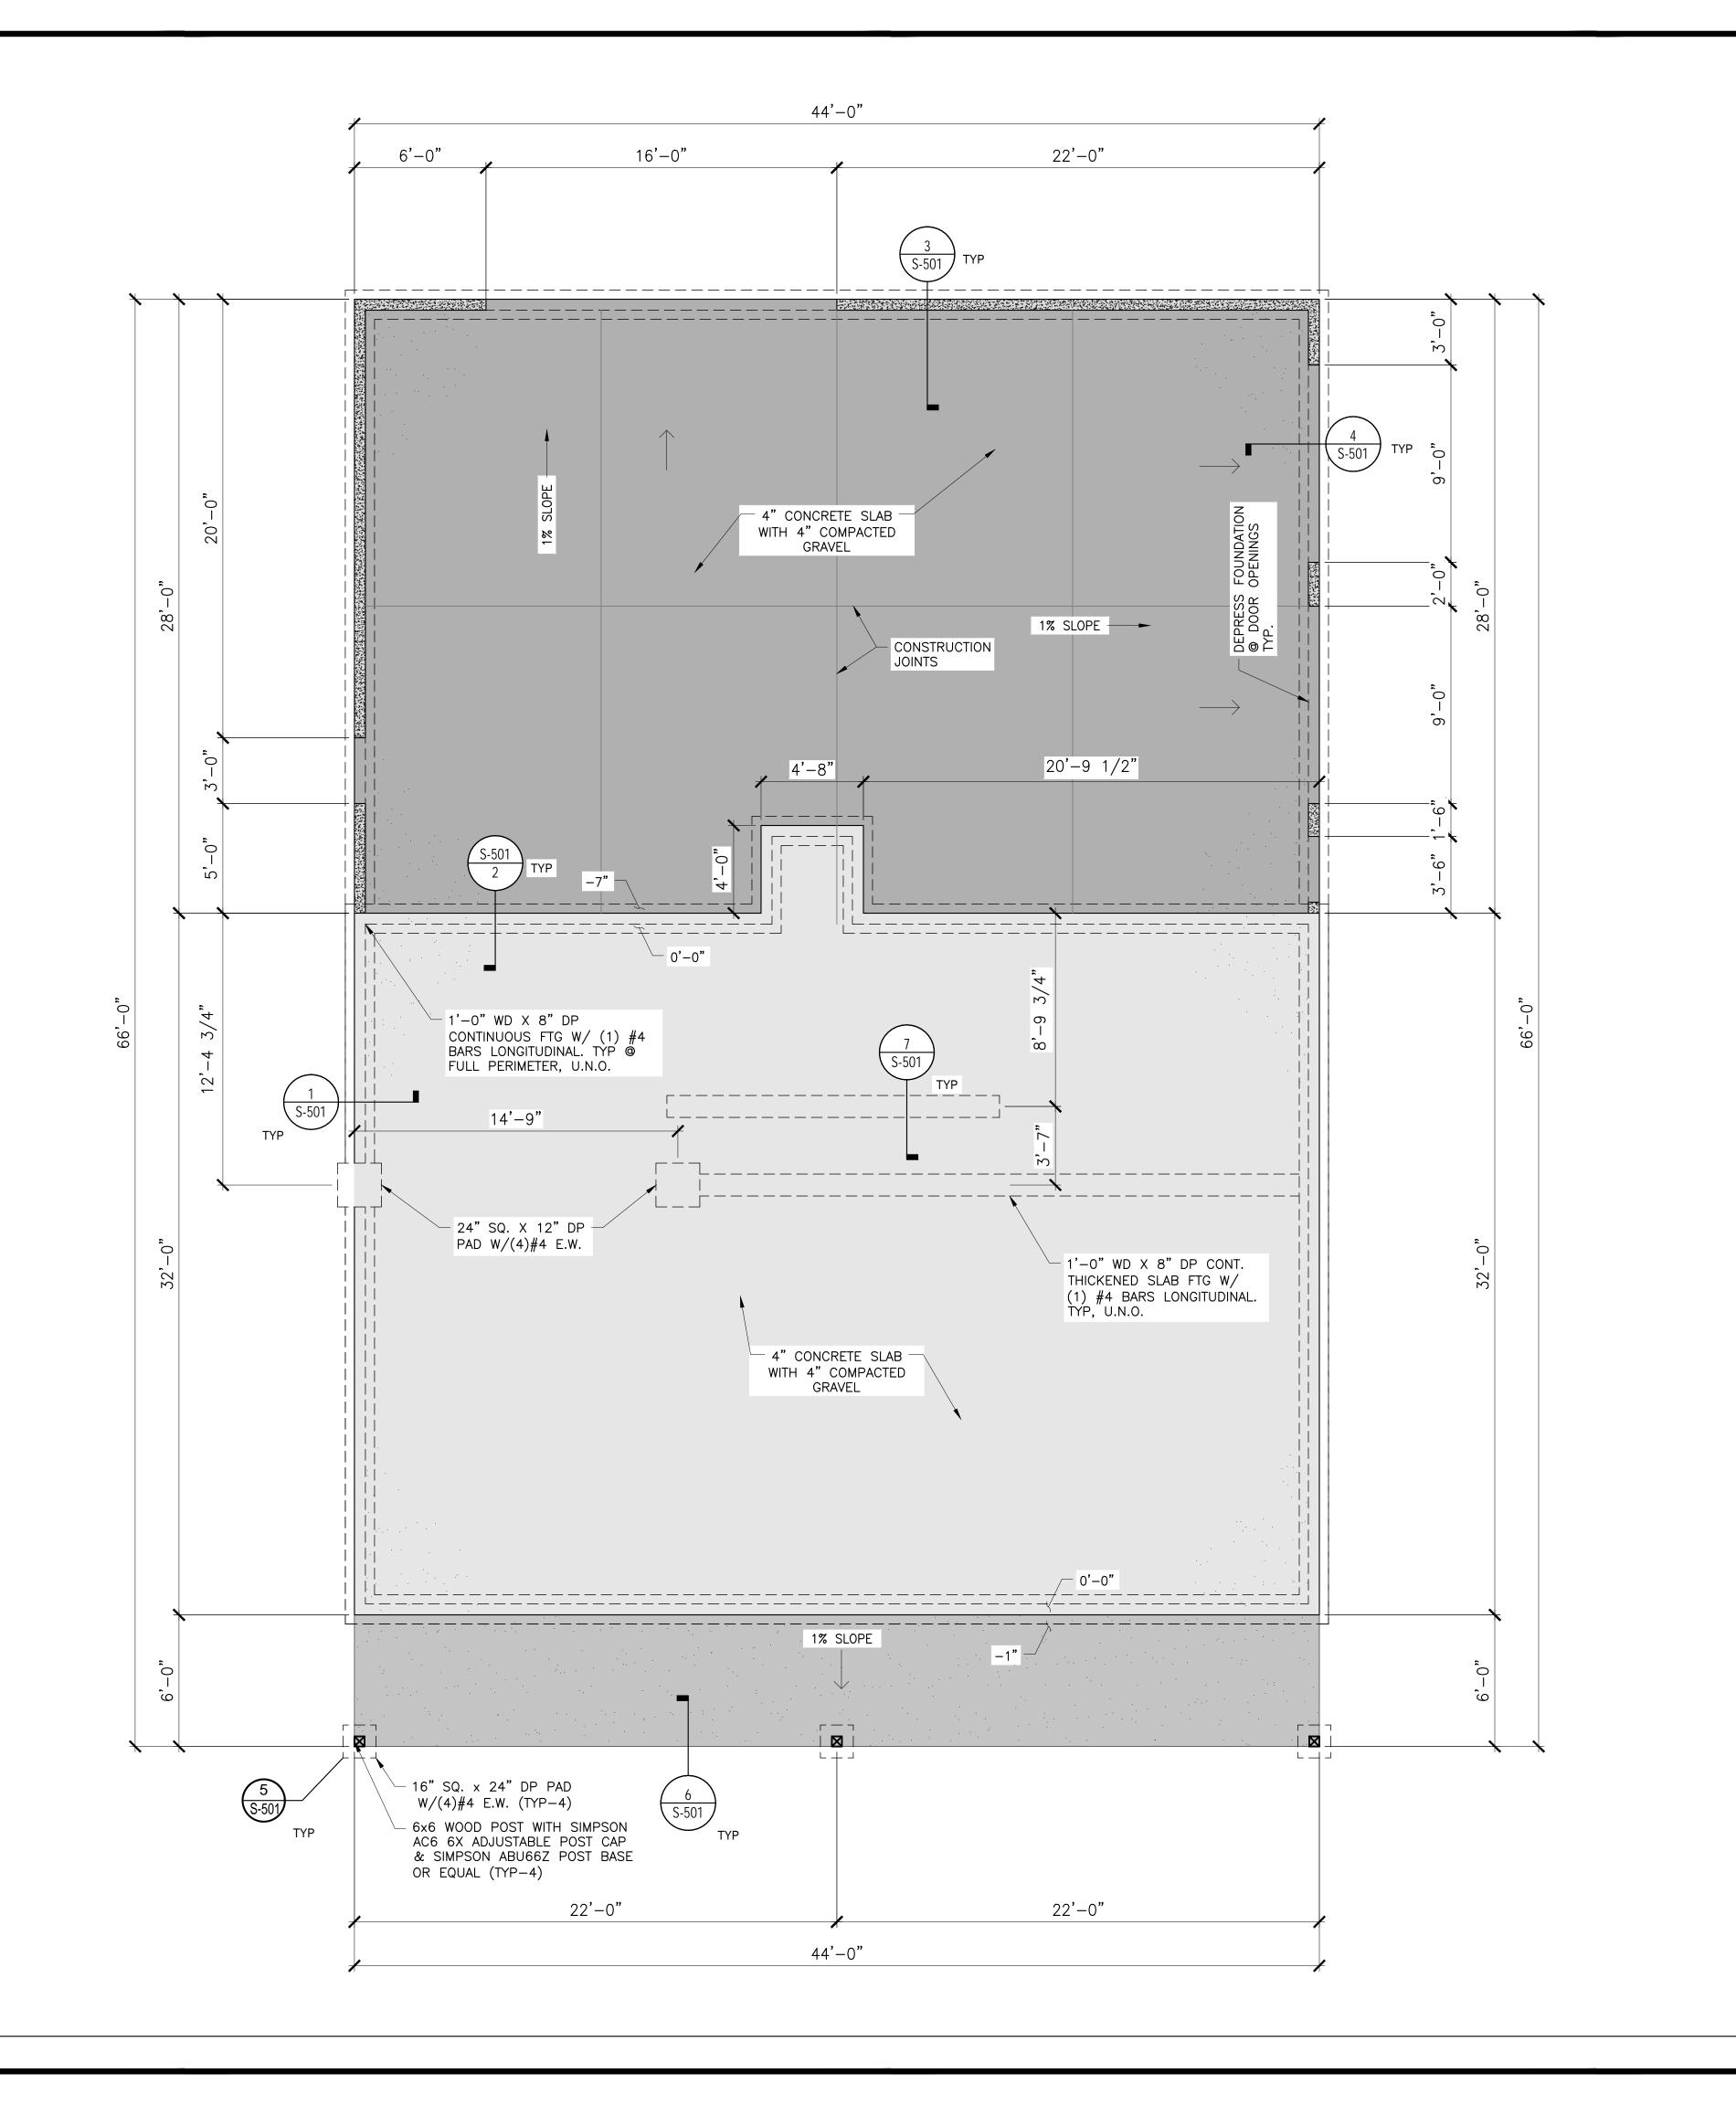

TYP. FOUNDATION NOTES:

- ALL METAL REINFORCEMENT SHALL BE GRADE
- CONC. F'c = 2,500 PSI IN 28 DAYS. 5-1/2
- BAG MIN. CEMENT VERIFIED BY CONTRACTOR. NO CLAY OR NON-VERIFIED BY CONTRACTOR. NO CLAY OR
- NON-ENGINEERED FILL BEARING SOILS
- ALL FOOTINGS SHALL BE PLACED ON UNDISTURBED SOIL OR 95% COMPACTED ENGINEERED FILL
- R408.5 REMOVAL OF DEBRIS. THE UNDER-FLOOR GRADE SHALL BE CLEANED OF ALL VEGETATION AND ORGANIC MATERIAL. ALL WOOD FORMS USED FOR PLACING CONCRETE SHALL BE REMOVED BEFORE A BUILDING IS
- OCCUPIED OR USED FOR ANY PURPOSE. AL CONSTRUCTION MATERIALS SHALL BE REMOVED BEFORE A BUILDING IS OCCUPIED OR USED FOR ANY PURPOSE. R408.6 FINISHED GRADE. THE FINISHED

GRADE OF UNDER-FLOOR SURFACE MAY BE

- LOCATED AT THE BOTTOM OF THE FOOTINGS; HOWEVER, WHERE THERE IS EVIDENCE THAT THE GROUNDWATER TABLE CAN RISE TO WITHIN 6" OF THE FINISHED FLOOR AT THE BUILDING PERIMETER OR WHERE THERE IS
- EVIDENCE THAT THE SURFACE WATER DOES NOT READILY DRAIN FROM THE BUILDING SIT THE GRADE IN THE UNDER-FLOOR SPACE SHALL BE AS HIGH AS THE OUTSIDE FINISHED GRADE, UNLESS AN APPROVED DRAINAGE SYSTEM IS PROVIDED.
- ALL CONCRETE SLABS SHALL HAVE CONTROL JOINTS AS REQUIRED.
- CONCRETE SIDEWALKS TO HAVE 34" TOOLED JOINTS AT 5' O.C. (MINIMUM).
- EXCAVATE THE SITE TO PROVIDE MINIMUM OF 18" CLEARANCE UNDER ALL GIRDERS AND JOISTS. "TEMCO" SEALANT (OR EQUAL).
- ALL WOOD IN CONTACT WITH CONCRETE OR 10 MASONRY TO BE
- PRESSURE-PRESERVATIVE-TREATED. SEE SHEAR WALL PLAN FOR COLUMN PLACEMENT AND MORE INFORMATION
- INSTALL 2x BLOCKING BELOW ALL PLUMBING FIXTURES, CONTRACTOR TO FIELD VERIFY

4/11/2023 9:39:32 AM

MILENKO@DRAFTCODESIGNS.COM WEB: DRAFTCODESIGNS.COM

509.251.5939


BUILDING INFO: MAIN LEVEL 1368 SECOND LEVEL

GARAGE COVERED ENTRY LIVING SPACE NON-LIVING SPACE TOTAL SCOPE

COPYRIGHT NOTICE: USE OF THESE PLANS WITHOUT EXPLICIT PERMISSION OF DRAFTCO DESIGNS LLC AND PAYMENT IS A COPYRIGHT VIOLATION WHICH MAY SUBJECT THE USER TO LIABILITY UNDER BOTH STATE AND FEDERAL LAW. THE BUILDER/OWNER IS LICENSED A ONE-TIME USE OF THESE PLANS. ALL PLANS ARE SITE SPECIFIC

FOUNDATION PLAN

SEE PRE-ENGINEERED TRUSS PACKAGE FOR MORE INFORMATION

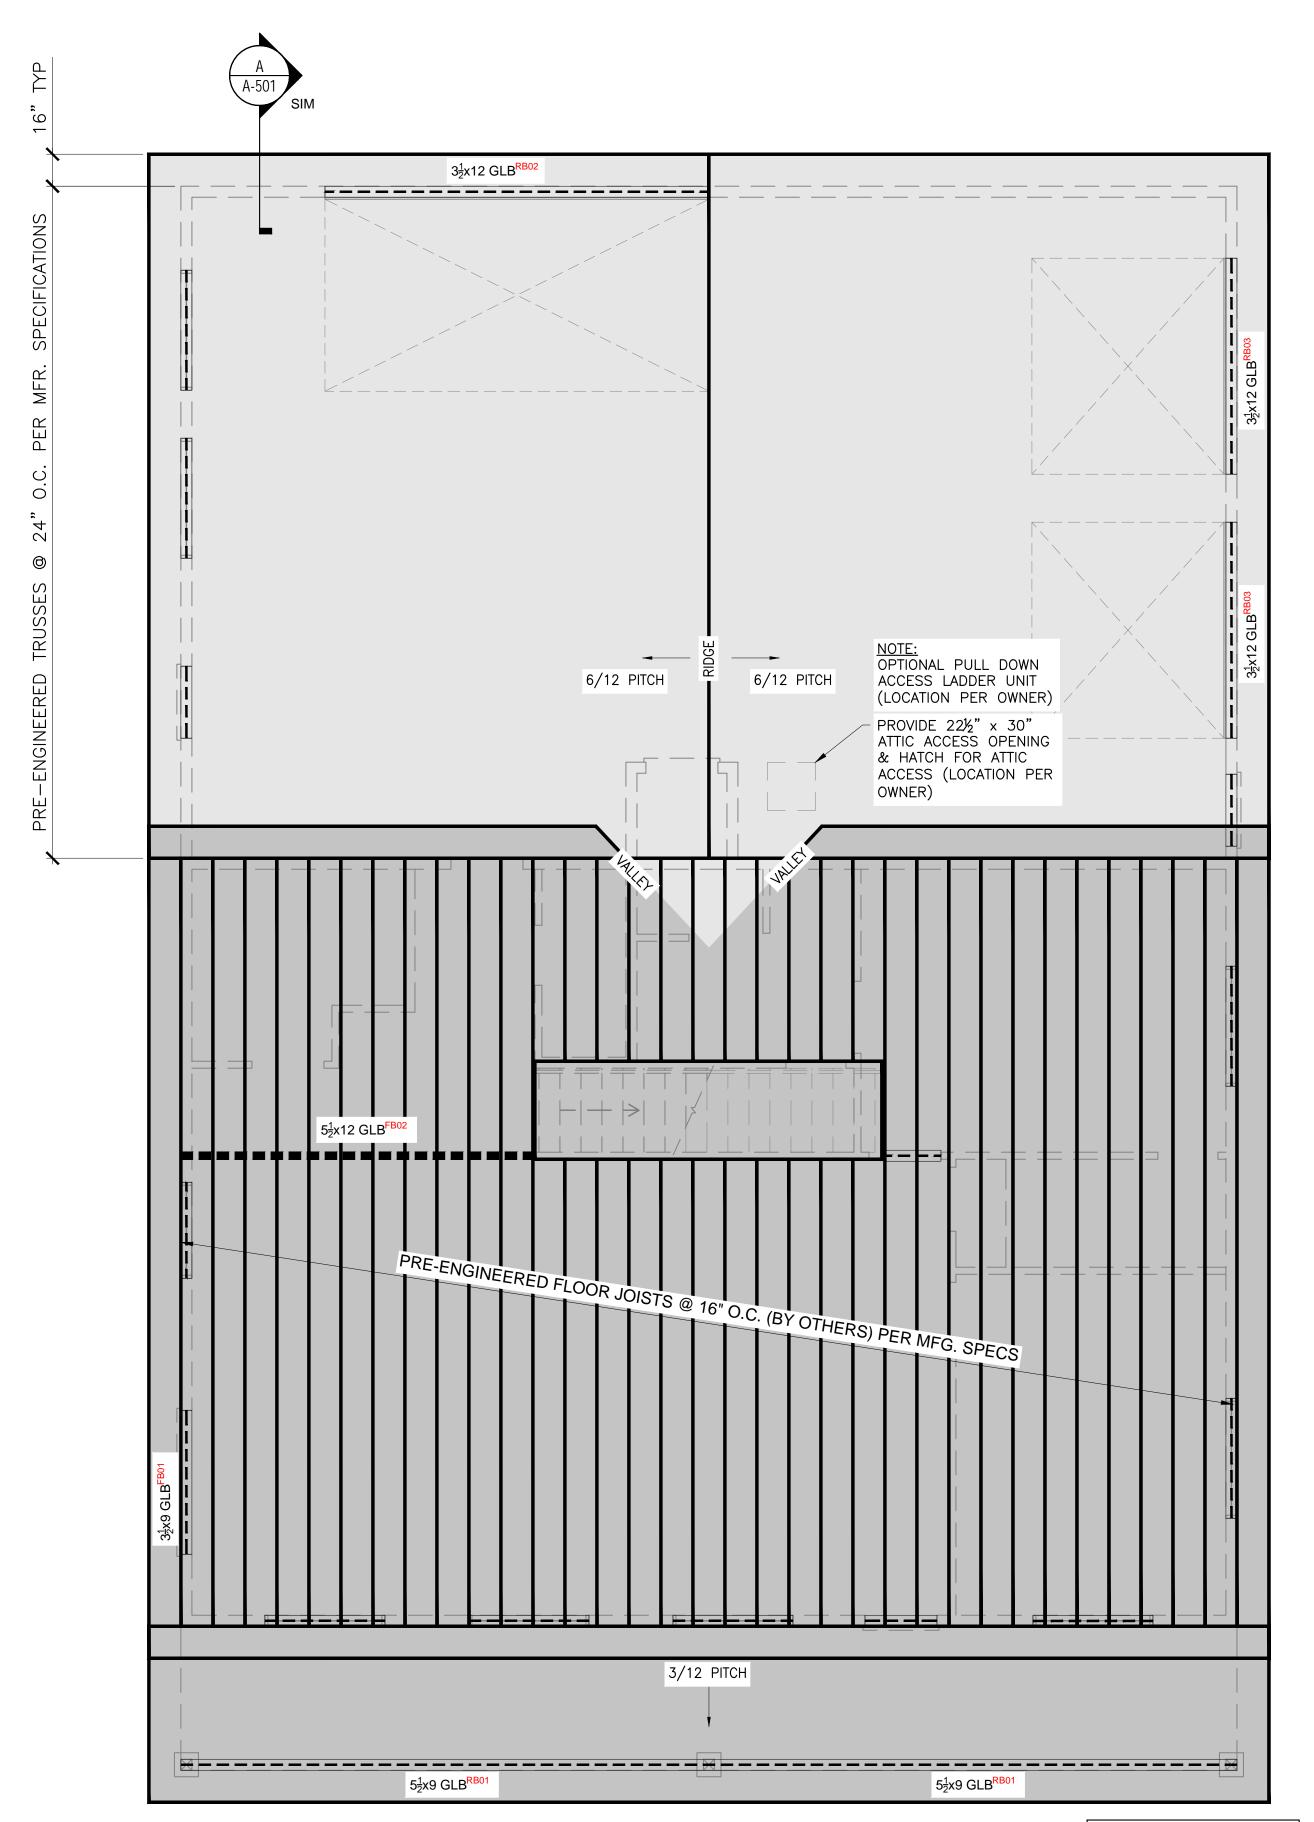

NOTE:
ALL DOOR AND WINDOW HEADERS TO BE (2)2x8 MIN UNLESS NOTED OTHERWISE.

TYP. ROOF FRAMING NOTES:

ROOF TRUSS DESIGN PER TRUSS

MANUFACTURER PRE-ENGINEERED ROOF TRUSSES SHALL BE HANDLED, ERECTED, INSTALLED, & BLOCKED AS PER MANUF'S SHOP DRAWING'S &

RECOMMENDATIONS STRUCTURAL FRAM'G LUMBER fs - 1200

ALL INTERIOR HEADERS TO BE (2) 2x6 | | VERTICAL & ALL EXTERIOR HEADERS TO BE (2) 2x8 VERTICAL UNLESS NOTED OTHERWIS PROVIDE SIMPSON H-2.5A CLIPS @ EVERY

OTHER ROOF TRUSS (OR APPROVED EQUAL) ROOF SHEATHING SHALL BE CLIPPED @ MID S SPAN W/ 8D NAILS @ 6" O.C. @ THE

ROOF SHEATHING 7/16" UNBLOCKED W/8d COMMON. 6" ALL EDGES/END NAILS 12" O.C. FIELD OR 1/2" UNBLOCKED W/ 10d COMMON NAILS @ 6" O.C. EDGES /12" O.C FIELD U.N.O.

EDGES & 12" O.C. IN THE FIELD

ROOF VENTILATION 1/150 SF PER IRC B R806.2. MAINTAIN MIN. 1½" AIR SPACE ABOVE INSULATION FOR VENTING ROOF SLOPE AS INDICATED ON DRAWINGS.

9 ROOF SLOPE SHALL NOT BE LESS THAN ¼":12" AT ANY LOCATIONS

FLASH AND COUNTER FLASH ALL ROOF PENETRATIONS

PLUMBING PENETRATIONS NOT SHOWN FOR 1 CLARITY. KEEP PLUMBING PENETRATIONS TO A MINIMUM.

PROVIDE BALANCED ROOF VENTILATION. IT IS RECOMMENDED THAT THE CONTRACTOR COORDINATE THE VENTING PRODUCT SUPPLIER TO PREVENT IMBALANCED VENTILATION UNDER SEVERE WEATHER CONDITIONS WHERE INFILTRATION COULD

OCCUR. WEATHER SHIELD FLASHING MAY BE REQUIRED AT THESE CONDITIONS. PROVIDE DRAFT STOPS IN ALL CONCEALED SPACES AT FLOOR-CEILING ASSEMBLIES WHEN THERE IS USABLE SPACE ABOVE OR BELOW THE CONCEALED SPACE. DRAFT

STOPS SHALL CONSIST OF 2x FRAMING OR

TRUSS MEMBER WITH 1/2" GWB EACH SIDE.

3 DRAFT STOPS SHALL DIVIDE THE CONCEALED SPACE TO INTO APPROXIMATELY EQUAL SPACES NOT TO EXCEED 1,000 SF EACH. DRAFT STOP CONSTRUCTION ASSEMBLY REQUIRED BY IRC. IN NO CASE SHALL A DRAFT STOP ASSEMBLY BE LESS THAN REQUIRED BY IRC SECTION R502.12. CONTRACTOR TO COORDINATE WITH THE TRUSS MANUFACTURER TO OBTAIN THEIR

CALCULATIONS, DRAWINGS AND SPECIFICATIONS AND REVIEW THEM TO MAKE SURE THEY WORK WITH THE DESIGN INTENT OF THE RESIDENCE. CONTRACTOR TO CONFIRM AND COORDINATE

THAT ALL TRUSSES HAVE: 1_MANUFACTURER'S STAMP ON PRE-MANUFACTURED TRUSSES. 2_BRACED (IF REQUIRED) TO MANUFACTURER'S

SPECIFICATIONS. 3_GIRDER AND FIELD ASSEMBLED TRUSSES, STRESS ANALYSIS AND DETAILS SHALL BE SUBMITTED TO BUILDING DEPARTMENT FOR APPROVAL. 4_WILL NOT BE FIELD ALTERED WITHOUT PRIOR BUILDING DEPARTMENT APPROVAL. 5_HAVE DESIGN DETAILS AND DRAWINGS ON SITE FOR FRAMING.

PROVIDE 221/2" x 30" ATTIC ACCESS OPENING & HATCH FOR ATTIC ACCESS (LOCATION PER OWNER/CONTRACTOR)

4/11/2023 9:39:03 AM

MILENKO@DRAFTCODESIGNS.COM WEB: DRAFTCODESIGNS.COM

> CA

509.251.5939


BUILDING INFO: MAIN LEVEL 1368 SECOND LEVEL GARAGE **COVERED ENTRY** 264 LIVING SPACE NON-LIVING SPACE TOTAL SCOPE

STOM HOME

COPYRIGHT NOTICE: USE OF THESE
PLANS WITHOUT EXPLICIT PERMISSION
OF DRAFTCO DESIGNS LLC AND
PAYMENT AS A CUPYRIGHT VIOLATION WHICH MAY SUBJECT THE USER TO LIABILITY UNDER BOTH STATE AND FEDERAL LAW. THE BUILDER/OWNER IS LICENSED A ONE-TIME USE OF THESE PLANS. ALL PLANS ARE SITE SPECIFIC.

2nd FLOOR FRAMING & **ROOF PLAN**

SEE PRE-ENGINEERED TRUSS PACKAGE FOR MORE INFORMATION

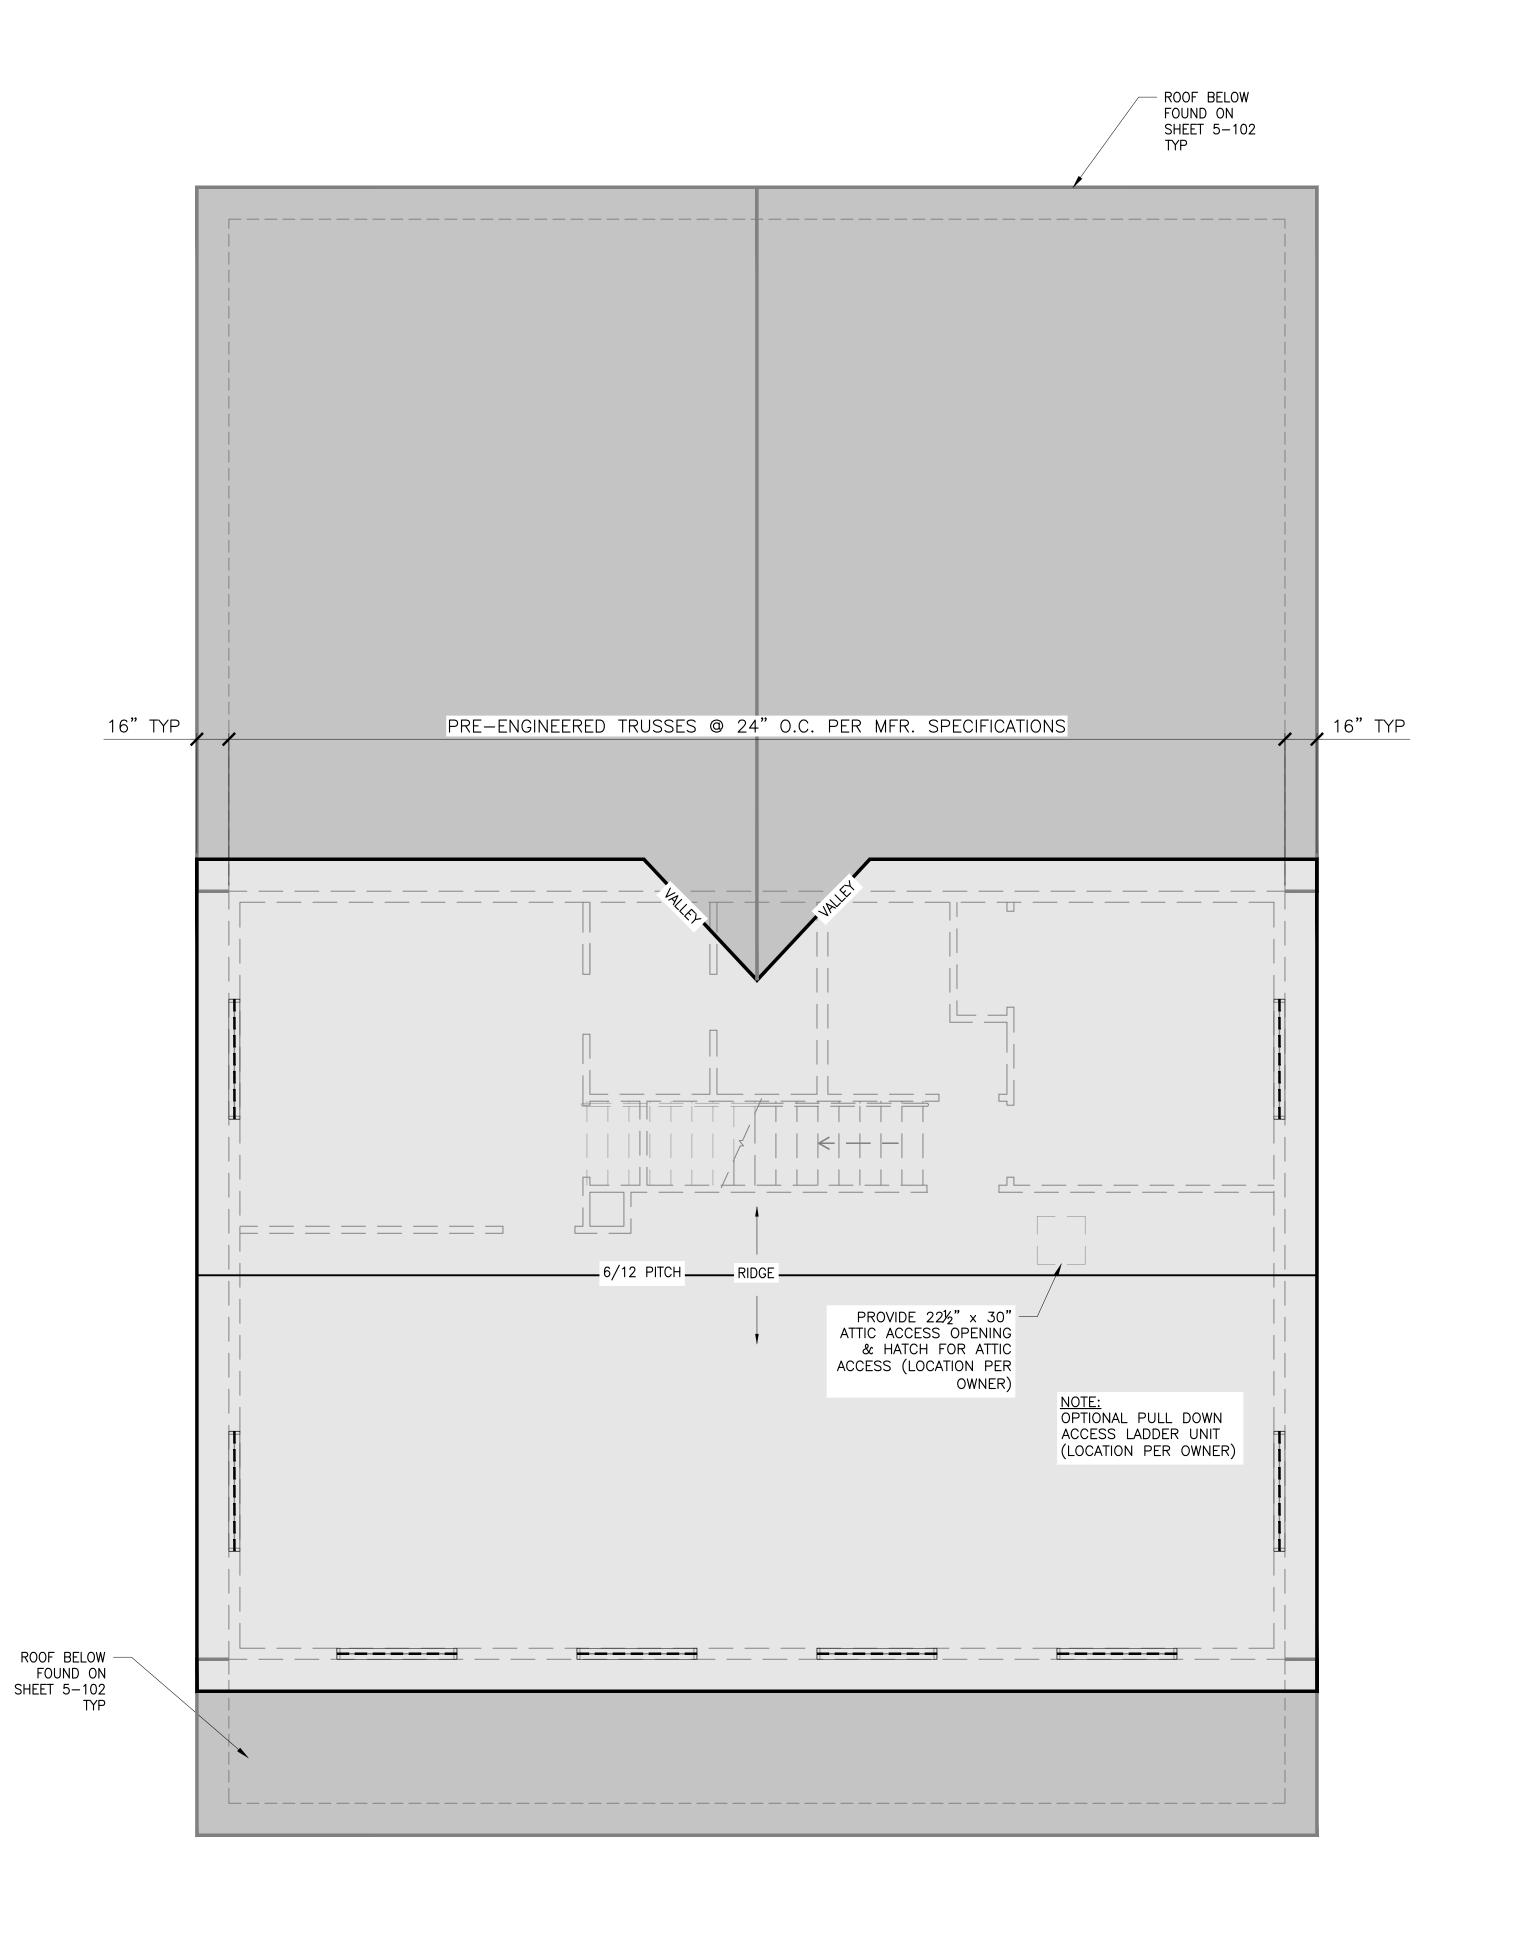

TYP. ROOF FRAMING NOTES:

ROOF TRUSS DESIGN PER TRUSS

MANUFACTURER

PRE-ENGINEERED ROOF TRUSSES SHALL BE HANDLED, ERECTED, INSTALLED, & BLOCKED AS PER MANUF'S SHOP DRAWING'S &

RECOMMENDATIONS

3 STRUCTURAL FRAM'G LUMBER fs — 1200

ALL INTERIOR HEADERS TO BE (2) 2x6
4 VERTICAL & ALL EXTERIOR HEADERS TO BE
(2) 2x8 VERTICAL UNLESS NOTED OTHERWISH

5 PROVIDE SIMPSON H-2.5A CLIPS @ EVERY OTHER ROOF TRUSS (OR APPROVED EQUAL)

ROOF SHEATHING SHALL BE CLIPPED @ MID

6 SPAN W/ 8D NAILS @ 6" O.C. @ THE EDGES & 12" O.C. IN THE FIELD

ROOF SHEATHING 7/16" UNBLOCKED W/8d COMMON. 6" ALL EDGES/END NAILS 12"

7 O.C. FIELD OR 1/2" UNBLOCKED W/ 10d

FIELD U.N.O.

ROOF VENTILATION 1/150 SF PER IRC

8 R806.2. MAINTAIN MIN. 1½" AIR SPACE
ABOVE INSULATION FOR VENTING

COMMON NAILS @ 6" O.C. EDGES /12" O.C.

ROOF SLOPE AS INDICATED ON DRAWINGS.

9 ROOF SLOPE SHALL NOT BE LESS THAN

1/4":12" AT ANY LOCATIONS

0 FLASH AND COUNTER FLASH ALL ROOF PENETRATIONS

PLUMBING PENETRATIONS NOT SHOWN FOR 1 CLARITY. KEEP PLUMBING PENETRATIONS TO A MINIMUM.

PROVIDE BALANCED ROOF VENTILATION. IT IS RECOMMENDED THAT THE CONTRACTOR COORDINATE THE VENTING PRODUCT SUPPLIER TO PREVENT IMBALANCED VENTILATION UNDER SEVERE WEATHER CONDITIONS WHERE INFILTRATION COULD

OCCUR. WEATHER SHIELD FLASHING MAY BE REQUIRED AT THESE CONDITIONS.

PROVIDE DRAFT STOPS IN ALL CONCEALED SPACES AT FLOOR—CEILING ASSEMBLIES WHEN THERE IS USABLE SPACE ABOVE OR BELOW THE CONCEALED SPACE. DRAFT STOPS SHALL CONSIST OF 2x FRAMING OR

TRUSS MEMBER WITH 1/2" GWB EACH SIDE.

DRAFT STOPS SHALL DIVIDE THE CONCEALED SPACE TO INTO APPROXIMATELY EQUAL SPACES NOT TO EXCEED 1,000 SF EACH. DRAFT STOP CONSTRUCTION ASSEMBLY REQUIRED BY IRC. IN NO CASE SHALL A DRAFT STOP ASSEMBLY BE LESS THAN REQUIRED BY IRC SECTION R502.12.

CONTRACTOR TO COORDINATE WITH THE TRUSS MANUFACTURER TO OBTAIN THEIR

CALCULATIONS, DRAWINGS AND SPECIFICATIONS AND REVIEW THEM TO MAKE SURE THEY WORK WITH THE DESIGN INTENT OF THE RESIDENCE.

CONTRACTOR TO CONFIRM AND COORDINATE

THAT ALL TRUSSES HAVE:

1_MANUFACTURER'S STAMP ON
PRE-MANUFACTURED TRUSSES. 2_BRACED
(IF REQUIRED) TO MANUFACTURER'S
SPECIFICATIONS. 3_GIRDER AND FIELD

ASSEMBLED TRUSSES, STRESS ANALYSIS AND DETAILS SHALL BE SUBMITTED TO BUILDING DEPARTMENT FOR APPROVAL. 4_WILL NOT BE FIELD ALTERED WITHOUT PRIOR BUILDING DEPARTMENT APPROVAL. 5_HAVE DESIGN DETAILS AND DRAWINGS ON SITE FOR FRAMING.

PROVIDE 22½" x 30" ATTIC ACCESS OPENING & HATCH FOR ATTIC ACCESS (LOCATION PER OWNER/CONTRACTOR)

4/11/2023 9:39:07 AM

MILENKO@DRAFTCODESIGNS.COM
WEB: DRAFTCODESIGNS.COM

BRAFTCO
ESIGNS LLC
ESIDENTIAL-COMMERCIA

509.251.5939

BUILDING INFO:

MAIN LEVEL 1427
SECOND LEVEL 1368
GARAGE 1213
COVERED ENTRY 264
LIVING SPACE 2795
NON-LIVING SPACE 1477
TOTAL SCOPE 4272

Job No. 22-161


WE KESIDENCE
CUSTOM HOME
781 BICKLETON HWY
GOLDENDALE, WA 98620


COPYRIGHT NOTICE: USE OF THESE PLANS WITHOUT EXPLICIT PERMISSION OF DRAFTCO DESIGNS LLC AND PAYMENT IS A COPYRIGHT VIOLATION WHICH MAY SUBJECT THE USER TO LIABILITY UNDER BOTH STATE AND FEDERAL LAW. THE BUILDER/OWNER IS LICENSED A ONE-TIME USE OF THESE PLANS. ALL PLANS ARE SITE SPECIFIC.

UPPER LEVEL ROOF PLAN

SHEET NO. :

S-103

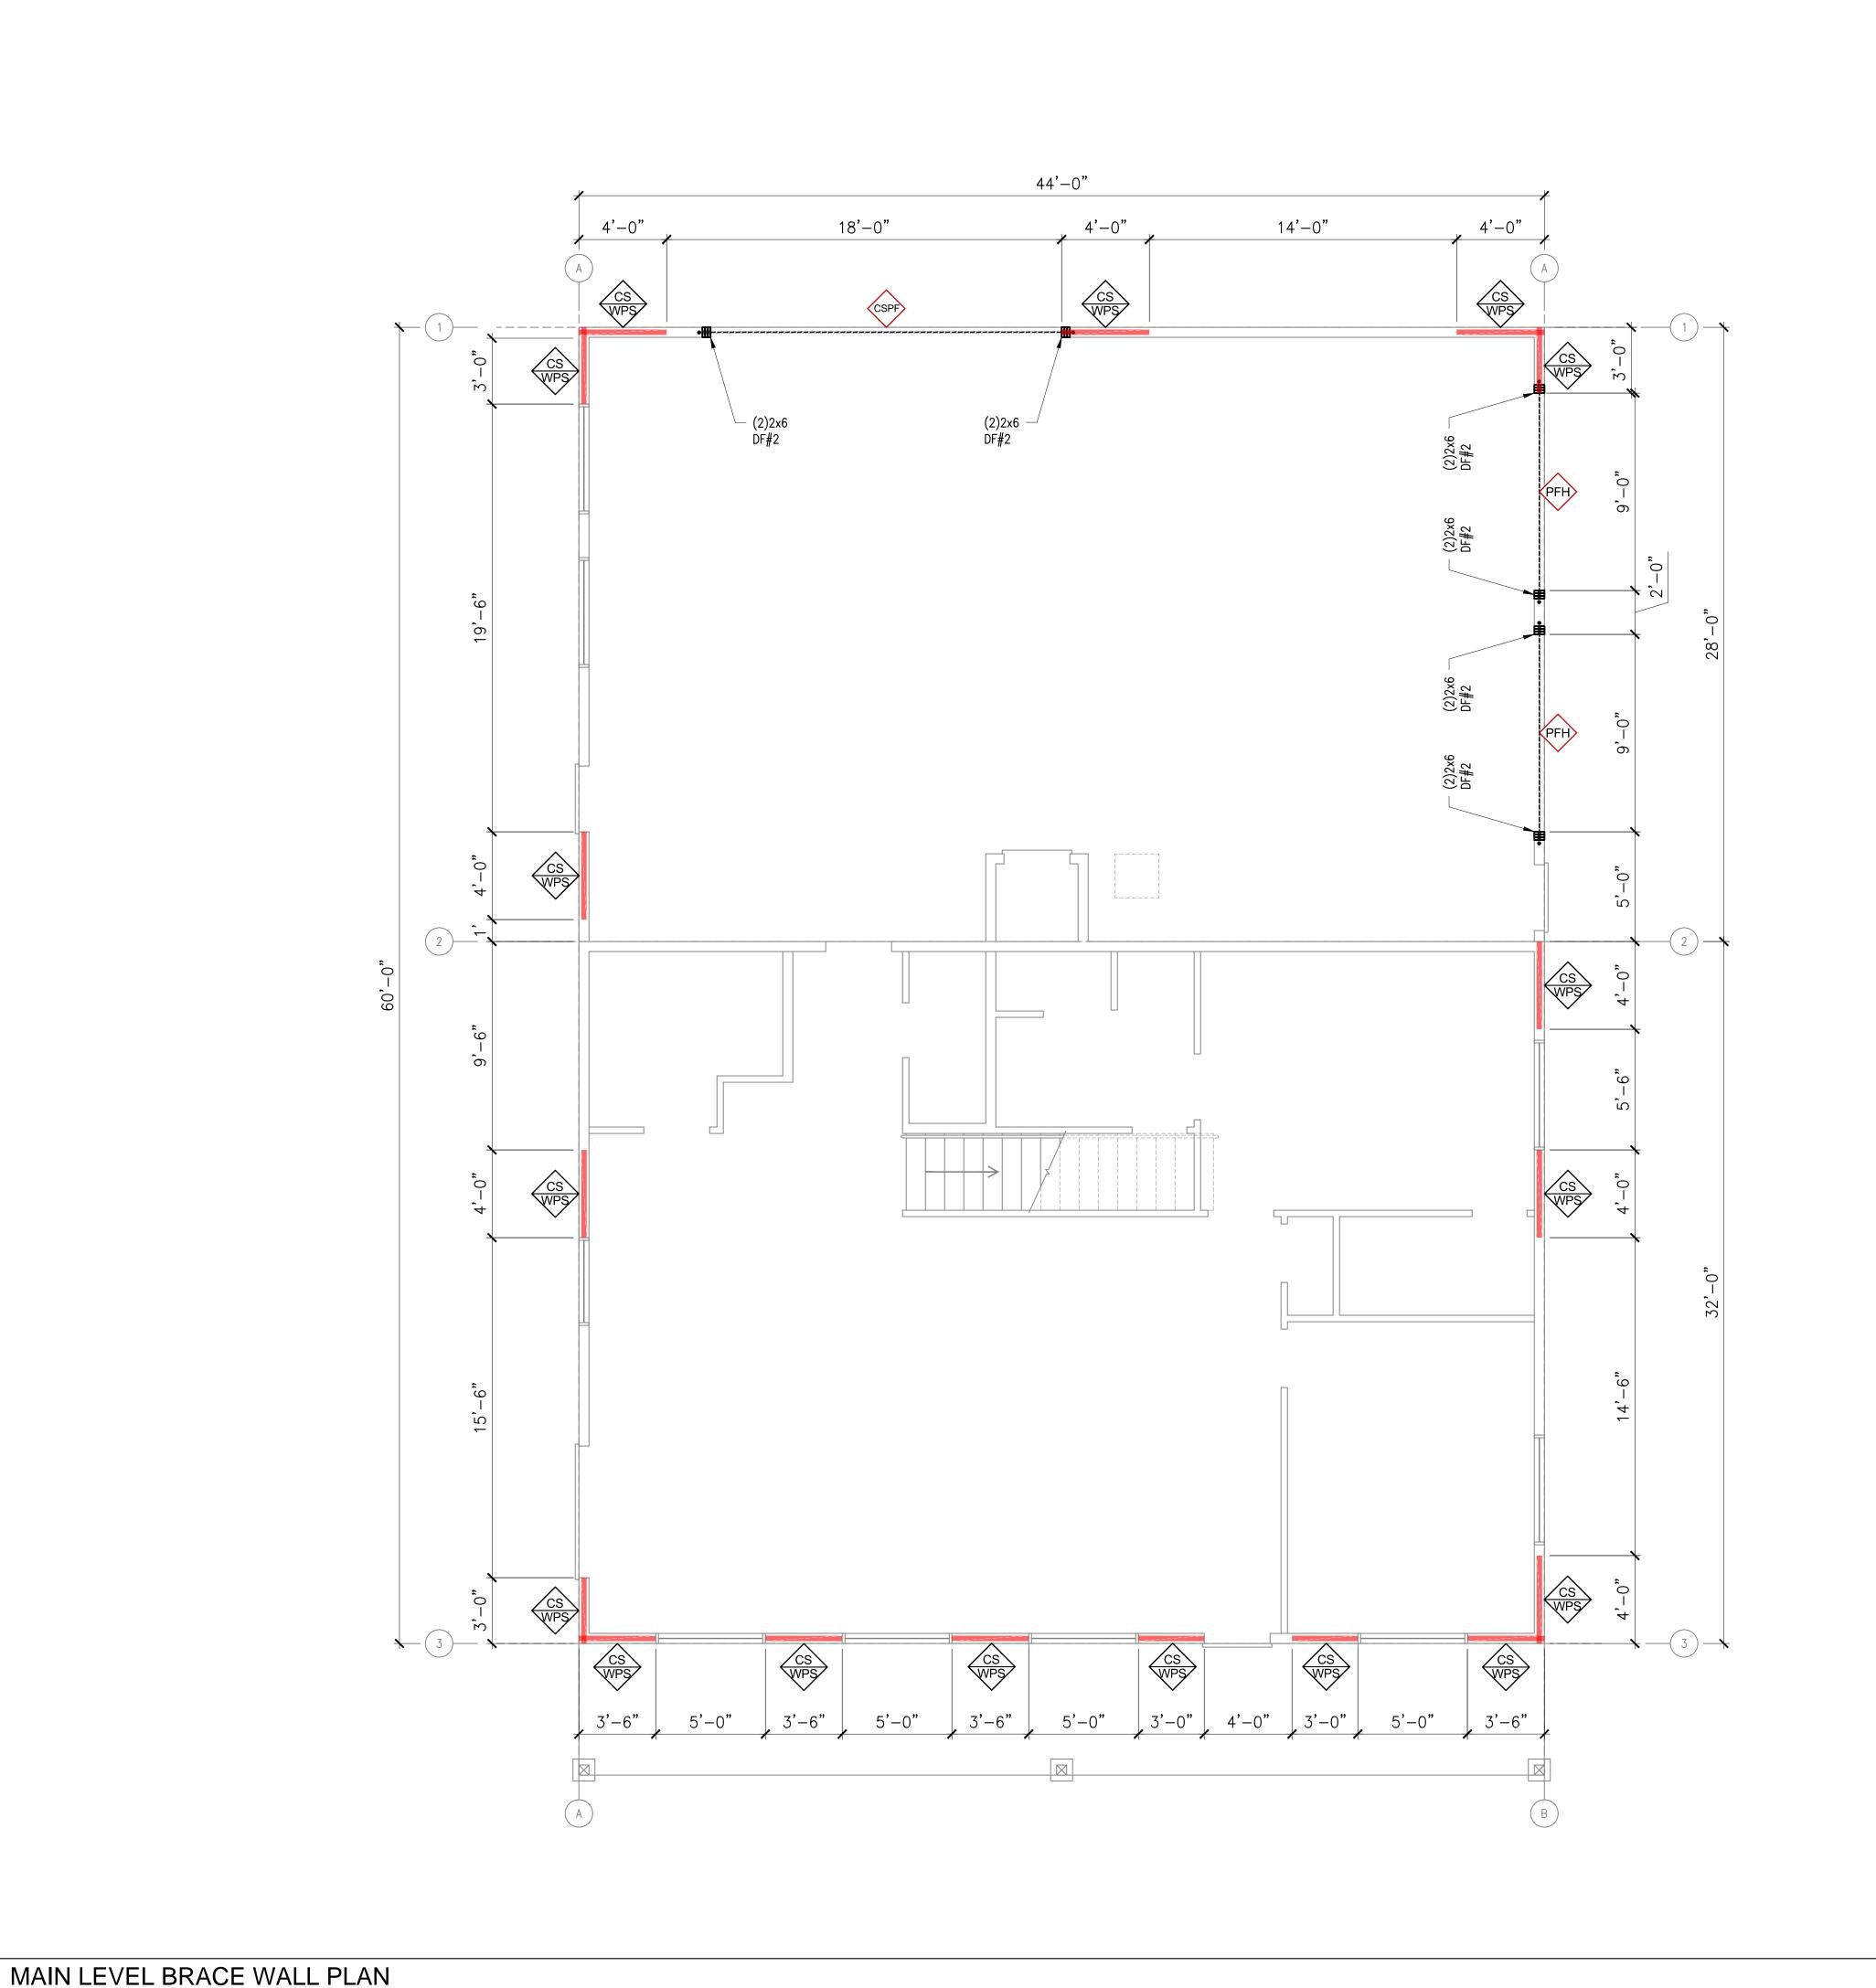

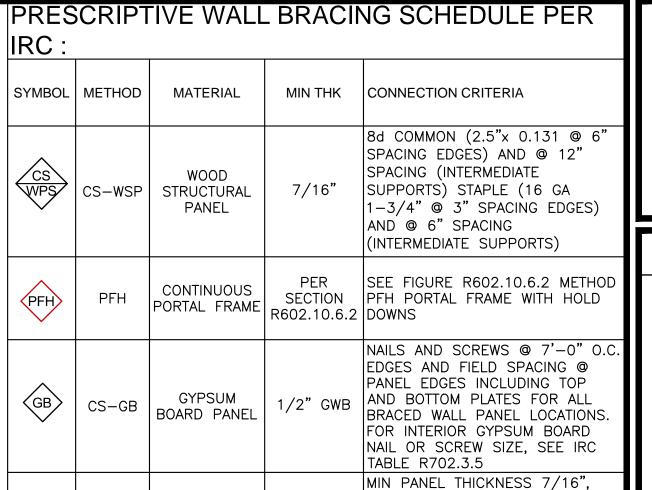

STRUCTURAL N	OTES:
--------------	-------

CSPF

CONTINUOUSLY

SHEATHED

1	INSTALL PANELS EITHER HORIZONTALLY OR VERTICALLY
2	WHERE SHEATHING IS APPLIED ON BOTH SIDES OF WALL, PANEL EDGE JOINTS ON 2X FRAMING SHALL BE STAGGERED SO THAT JOINTS ON THE OPPOSITE SIDES ARE NOT LOCATED ON THE SAME STUDS.

PER

PORTAL FRAME R602.10.6.4 STUDS, SEE IRC TABLE

1/2" SPACERS, 8D NAILS IN GRII

SECTION PATTERN, 6-16D NAILS IN KING

BLOCKING IS REQUIRED AT ALL WOOD SHEATHING PANEL EDGES.
BLOCKING IS NOT REQUIRED ON GYPSUM BOARD SHEATHING PANEL EDGES.

PROVIDE SHEAR WALL SHEATHING AND NAILING FOR THE ENTIRE LENGTH OF THE WALLS INDICATED ON THE PLANS. ENDS OF FULL HEIGHT WALLS ARE DESIGNATED BY EXTERIOR OF THE BUILDING, CORRIDORS, WINDOWS, OR DOORWAYS OR AS DESIGNATED ON PLANS. SEE PLANS FOR HOLDOWN REQUIREMENTS.

SHEATHING EDGE NAILING IS REQUIRED AT ALL HOLDOWN POSTS. EDGE NAILING MAY ALSO BE REQUIRED TO EACH STUD USED IN BUILT—UP HOLDOWN POSTS.

INTERMEDIATE FRAMING TO BE 2X MINIMUM MEMBERS. FIELD NAILING 12"
OC FOR WOOD SHEATHING. GYPSUM BOARD NAILING TO BE AS SHOWN FOR ALL STUDS.

IF CLIPS ARE USED INSTEAD OF TOE-NAILS, USE 8d x 1 ½" LONG NAILS USED TO ATTACH FRAMING CLIPS DIRECTLY TO FRAMING. USE 8d x 2 ½"

LONG NAILS WHERE INSTALLED OVER SHEATHING.


IF CLIPS ARE USED, FRAMING CLIPS: A35 OR LTP5 OR APPROVED

EQUIVALENT

9 WHERE PLATE ATTACHMENT SPECIFIES (2) ROWS OF NAILS, PROVIDE DOUBLE JOIST, RIM OR EQUAL. ATTACH PER DETAILS.

(IN SEISMIC DESIGN CATEGORIES D,E&F) ANCHOR BOLTS SHALL BE
10 PROVIDED WITH STEEL PLATE WASHERS 3/6"x2"x2". EMBED ANCHOR BOLTS
7" MINIMUM INTO THE CONCRETE.

PRESSURE TREATED MATERIAL CAN CAUSE EXCESSIVE CORROSION IN THE FASTENERS. PROVIDE HOT-DIPPED GALVANIZED (ELECTRO-PLATING IS NOT ACCEPTABLE) NAILS AND CONNECTOR PLATES (FRAMING ANGLES, ETC.) FOR ALL CONNECTORS IN CONTACT WITH PRESSURE TREATED FRAMING MEMBERS

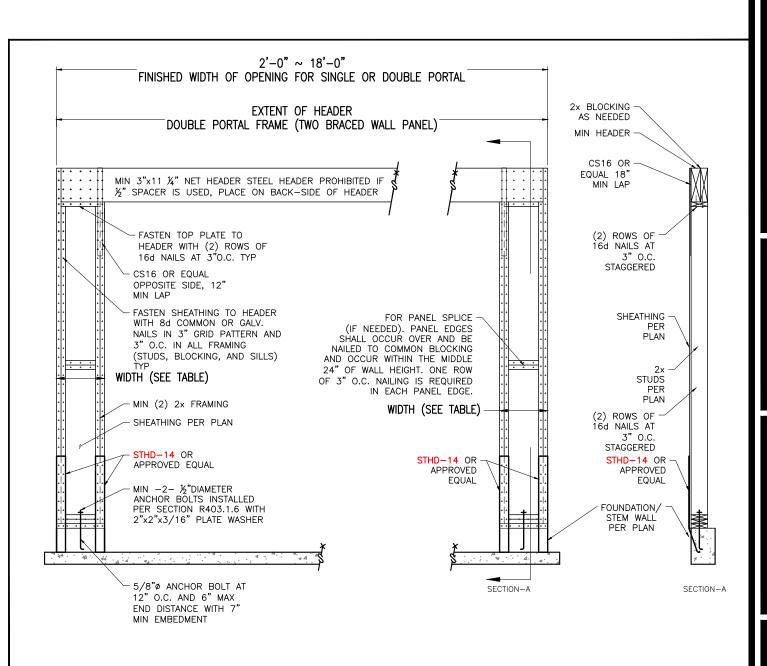

4/11/2023 9:39:39 AM

MILENKO@DRAFTCODESIGNS.COM

BESIDENTIAL-COMMERCIAL
RESIDENTIAL-COMMERCIAL

509.251.5939

BUILDING INFO:

MAIN LEVEL 1427

SECOND LEVEL 1368

GARAGE 1213

COVERED ENTRY 264

LIVING SPACE 2795

NON-LIVING SPACE 1477

TOTAL SCOPE 4272

Job No. 22-161


WE RESIDENCE
CUSTOM HOME
781 BICKLETON HWY
GOLDENDALE, WA 98620

COPYRIGHT NOTICE: USE OF THESE PLANS WITHOUT EXPLICIT PERMISSION OF DRAFTCO DESIGNS LLC AND PAYMENT IS A COPYRIGHT VIOLATION WHICH MAY SUBJECT THE USER TO LIABILITY UNDER BOTH STATE AND FEDERAL LAW. THE BUILDER/OWNER IS LICENSED A ONE-TIME USE OF THESE PLANS. ALL PLANS ARE SITE SPECIFIC.

MAIN LEVEL BRACE WAL PLAN

SHEET NO.:
S-104

2 PFH - OHD PORTAL FRAME PER TABLE R602.10.6.2

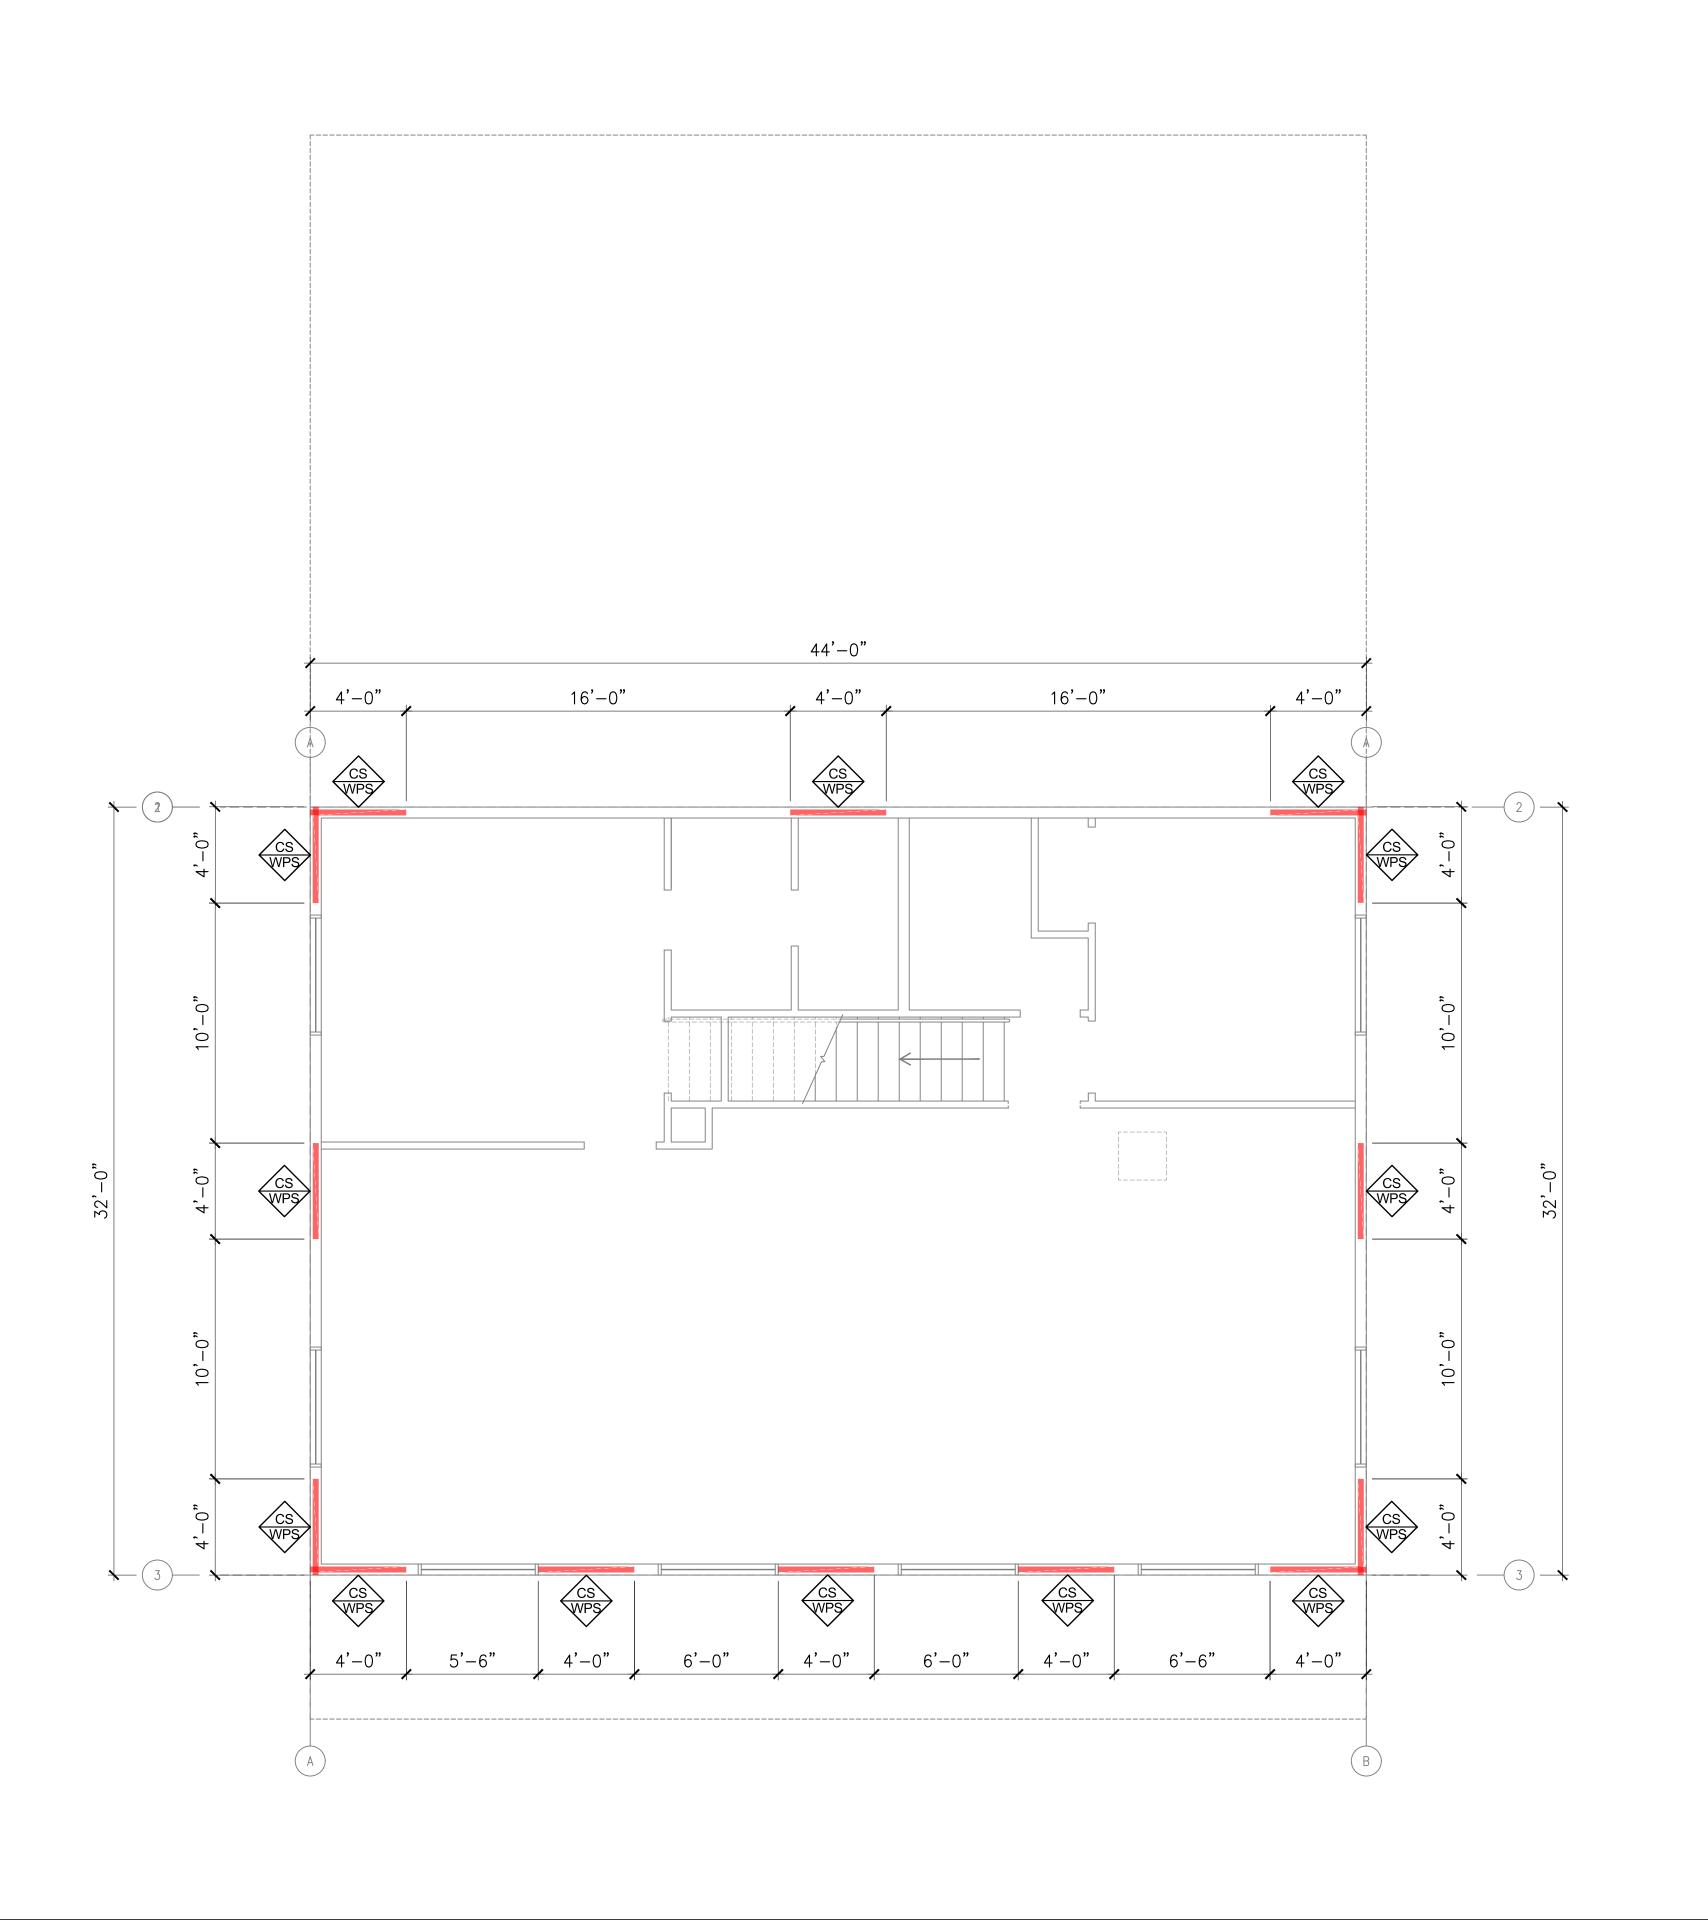

SECOND LEVEL BRACE WALL PLAN

PRESCRIPTIVE WALL BRACING SCHEDULE PER

SYMBOL | METHOD | MATERIAL | MIN THK | CONNECTION CRITERIA 8d COMMON (2.5"x 0.131 @ 6" SPACING EDGES) AND @ 12" SPACING (INTERMEDIATE SUPPORTS) STAPLE (16 CS CS-WSP STRUCTURAL 7/16" GA 1-3/4" @ 3" SPACING EDGES) PANEL AND @ 6" SPACING (INTERMEDIATE SUPPORTS) CONTINUOUS PFH SECTION SEE FIGURE R602.10.6.2 METHOD PFI PFH PORTAL R602.10. PORTAL FRAME WITH HOLD DOWNS FRAME 6.2 NAILS AND SCREWS @ 7'-0" O.C. EDGES AND FIELD SPACING @ PANEL

STRUCTURAL NOTES:

CS-GB

GB

GYPSUM

BOARD

PANEL

INSTALL PANELS EITHER HORIZONTALLY OR VERTICALLY
WHERE SHEATHING IS APPLIED ON BOTH SIDES OF WALL, PANEL EDGE JOINTS ON 2X FRAMING SHALL BE STAGGERED SO THAT JOINTS ON THE OPPOSITE SIDES ARE NOT LOCATED ON THE SAME STUDS.

EDGES INCLUDING TOP AND BOTTOM

LOCATIONS. FOR INTERIOR GYPSUM BOARD NAIL OR SCREW SIZE, SEE IRC

TABLE R702.3.5

PLATES FOR ALL BRACED WALL PANEL

- BLOCKING IS REQUIRED AT ALL WOOD SHEATHING PANEL EDGES. BLOCKING IS NOT REQUIRED ON GYPSUM BOARD SHEATHING PANEL EDGES
- PROVIDE SHEAR WALL SHEATHING AND NAILING FOR THE ENTIRE LENGTH OF THE WALLS INDICATED ON THE PLANS. ENDS OF FULL HEIGHT WALLS ARE DESIGNATED BY EXTERIOR OF THE BUILDING, CORRIDORS, WINDOWS, OR DOORWAYS OR AS DESIGNATED ON PLANS. SEE PLANS FOR HOLDOWN
- SHEATHING EDGE NAILING IS REQUIRED AT ALL HOLDOWN POSTS. EDGE NAILING MAY ALSO BE REQUIRED TO EACH STUD USED IN BUILT-UP HOLDOWN POSTS.
- INTERMEDIATE FRAMING TO BE 2X MINIMUM MEMBERS. FIELD NAILING 12 OC FOR WOOD SHEATHING. GYPSUM BOARD NAILING TO BE AS SHOWN FOR ALL STUDS.

IF CLIPS ARE USED INSTEAD OF TOE-NAILS, USE 8d x 1 ½" LONG NAILS

- USED TO ATTACH FRAMING CLIPS DIRECTLY TO FRAMING. USE 8d x 2 1/2" | LONG NAILS WHERE INSTALLED OVER SHEATHING.
- IF CLIPS ARE USED, FRAMING CLIPS: A35 OR LTP5 OR APPROVED EQUIVALENT
- WHERE PLATE ATTACHMENT SPECIFIES (2) ROWS OF NAILS, PROVIDE DOUBLE JOIST, RIM OR EQUAL. ATTACH PER DETAILS.
- (IN SEISMIC DESIGN CATEGORIES D,E&F) ANCHOR BOLTS SHALL BE 10 PROVIDED WITH STEEL PLATE WASHERS 3/6"x2"x2". EMBED ANCHOR BOLTS 7" MINIMUM INTO THE CONCRETE.
- PRESSURE TREATED MATERIAL CAN CAUSE EXCESSIVE CORROSION IN THE FASTENERS. PROVIDE HOT-DIPPED GALVANIZED (ELECTRO-PLATING IS NOT 11 ACCEPTABLE) NAILS AND CONNECTOR PLATES (FRAMING ANGLES, ETC.) FOR ALL CONNECTORS IN CONTACT WITH PRESSURE TREATED FRAMING

4/11/2023 9:38:58 AM

CIA

MILENKO@DRAFTCODESIGNS.COM

WEB: DRAFTCODESIGNS.COM

RESIDE

509.251.5939

BUILDING INFO: MAIN LEVEL 1368 SECOND LEVEL GARAGE COVERED ENTRY LIVING SPACE NON-LIVING SPACE TOTAL SCOPE

Job No. 22-161


781 BICKLETON HWY GOLDENDALE, WA 986; **CUSTOM HOME**

COPYRIGHT NOTICE: USE OF THESE
PLANS WITHOUT EXPLICIT PERMISSION
OF DRAFTCO DESIGNS LLC AND
PAYMENT IS A COPYRIGHT VIOLATION WHICH MAY SUBJECT THE USER TO LIABILITY UNDER BOTH STATE AND FEDERAL LAW. THE BUILDER/OWNER IS LICENSED A ONE-TIME USE OF THESE PLANS. ALL PLANS ARE SITE SPECIFIC


SECOND **LEVEL** WALL PLAN

SHEET NO. :

S-105

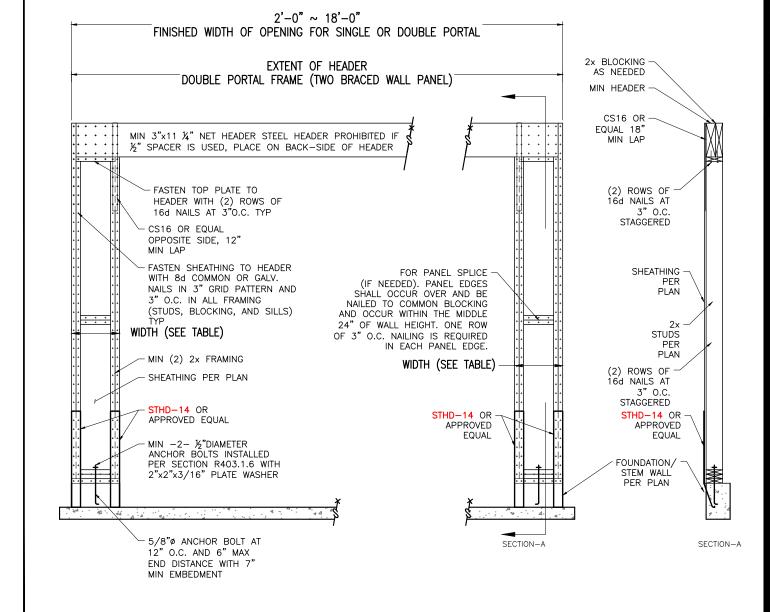

PFH - OHD PORTAL FRAME PER TABLE R602.10.6.2

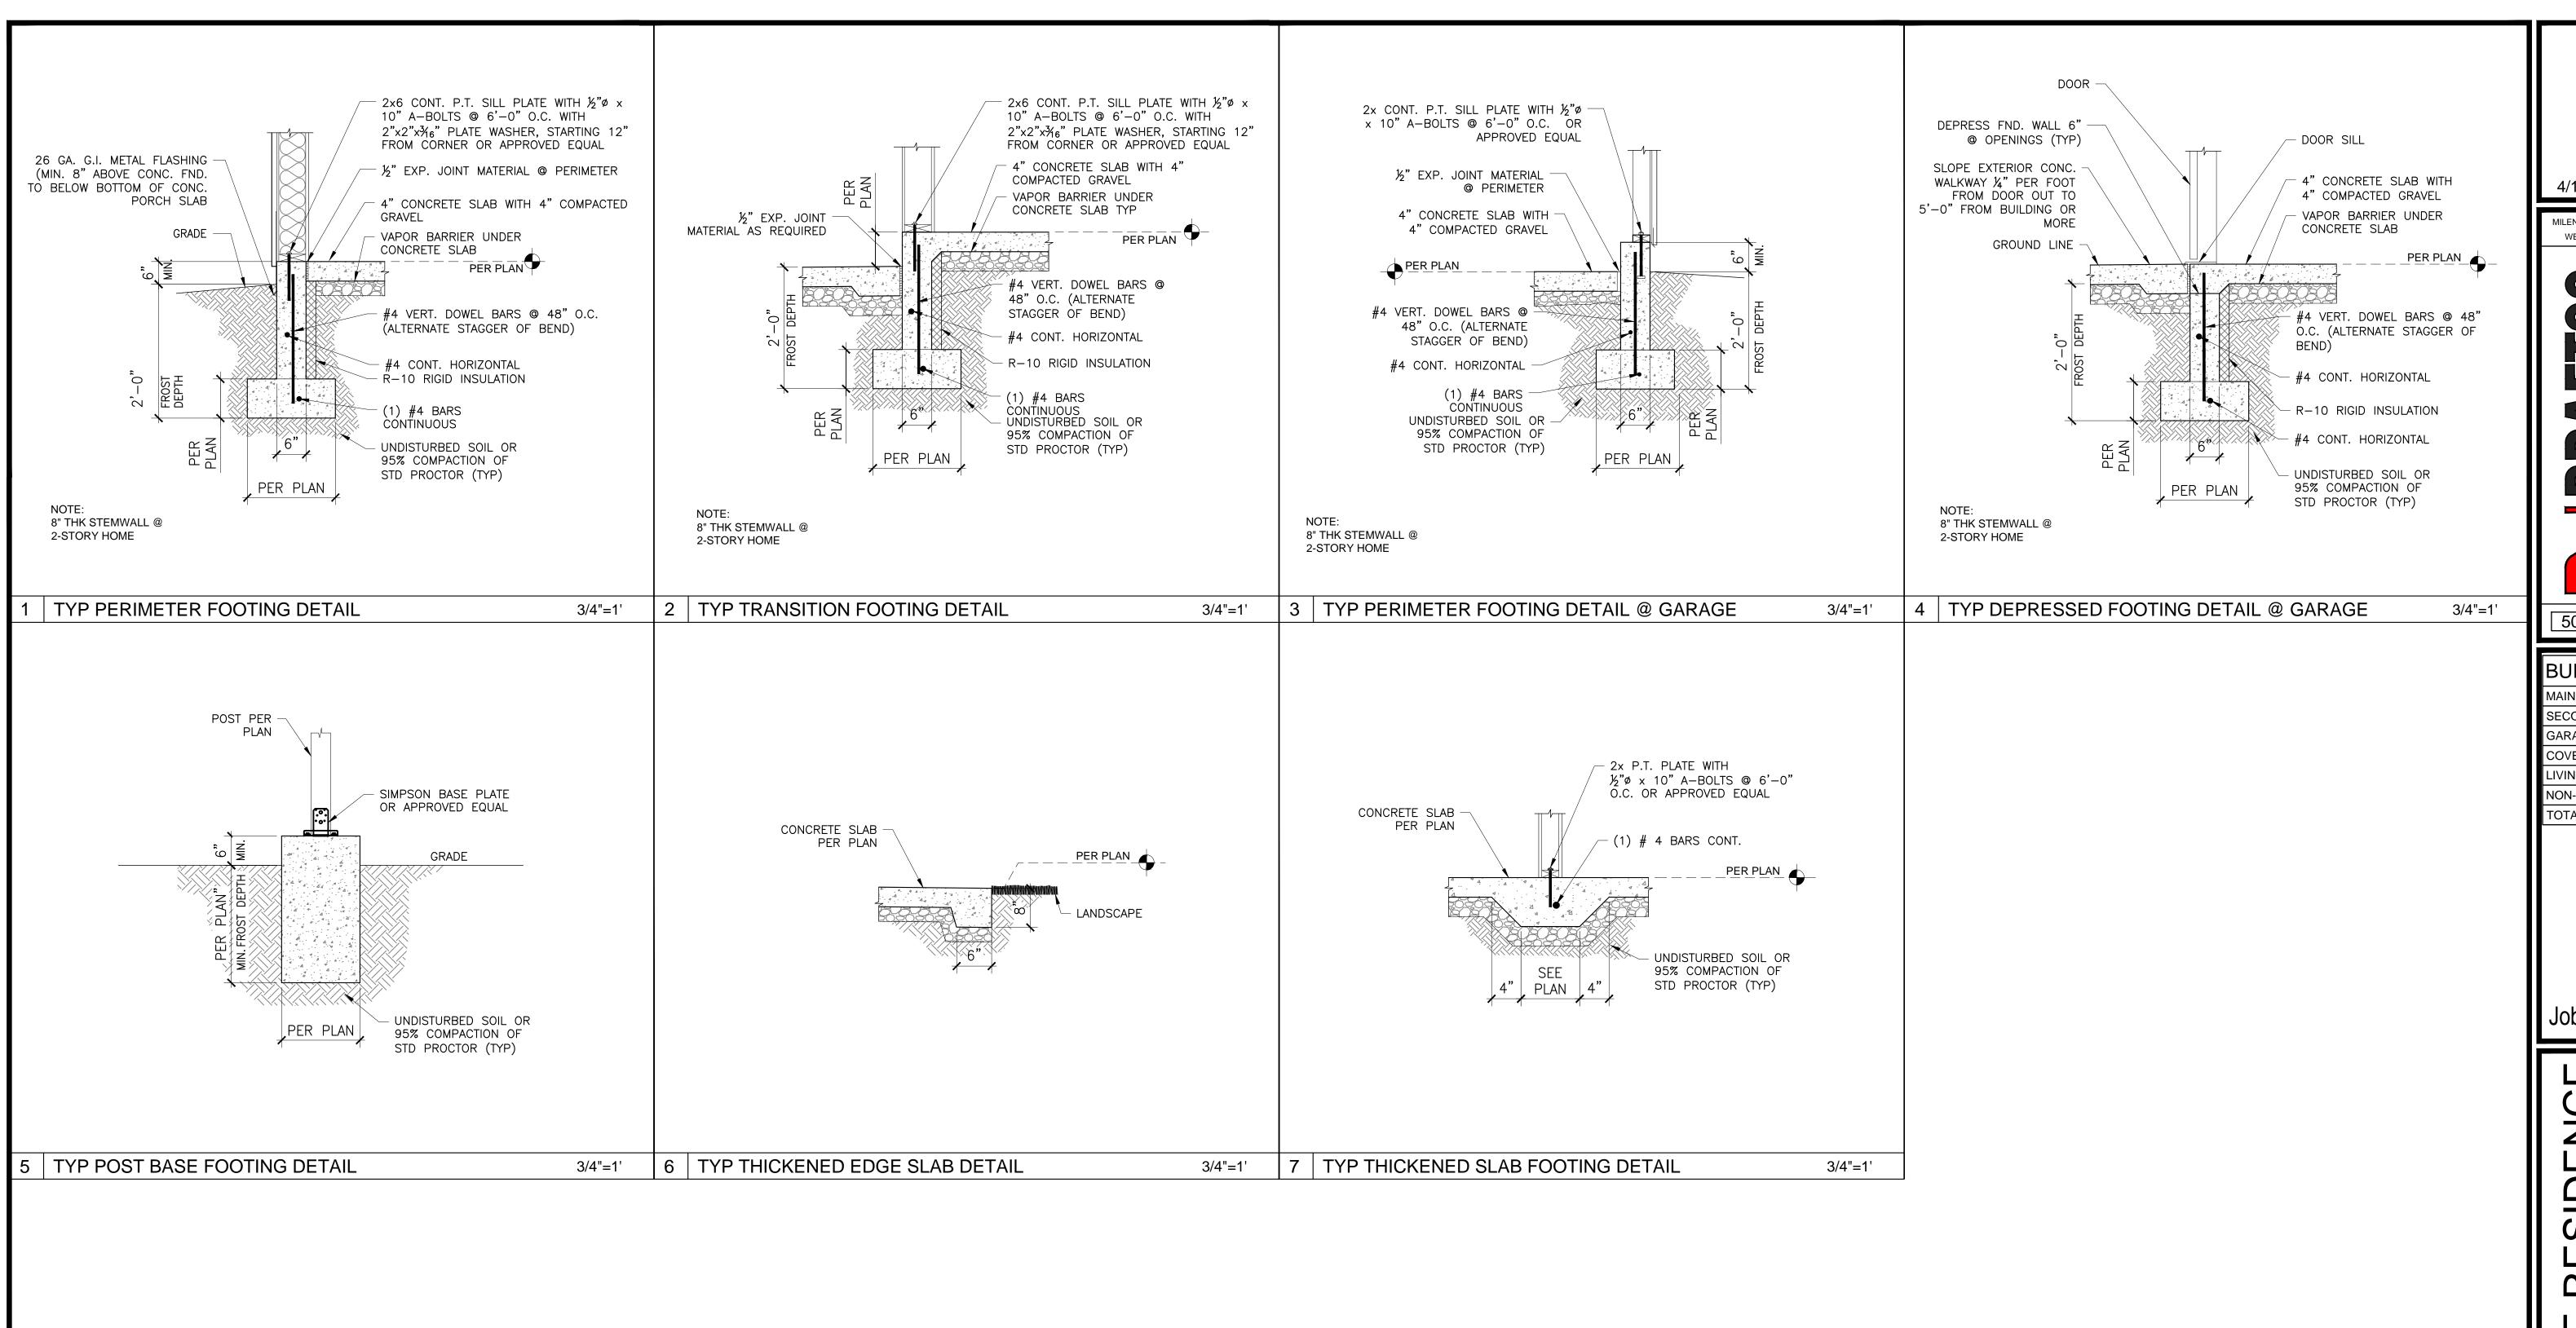

4/11/2023 9:38:47 AM

MILENKO@DRAFTCODESIGNS.COM
WEB: DRAFTCODESIGNS.COM

RESIDENTIAL-COMMERCIAL

509.251.5939

BUILDING INF	O:
MAIN LEVEL	1427
SECOND LEVEL	1368
GARAGE	1213
COVERED ENTRY	264
LIVING SPACE	2795
NON-LIVING SPACE	1477
TOTAL SCOPE	4272
·	


Job No. 22-161

OWE RESIDENCE
CUSTOM HOME
781 BICKLETON HWY

COPYRIGHT NOTICE: USE OF THESE PLANS WITHOUT EXPLICIT PERMISSION OF DRAFTCO DESIGNS LLC AND PAYMENT IS A COPYRIGHT VIOLATION WHICH MAY SUBJECT THE USER TO LIABILITY UNDER BOTH STATE AND FEDERAL LAW. THE BUILDER/OWNER IS LICENSED A ONE-TIME USE OF THESE PLANS. ALL PLANS ARE SITE SPECIFIC.

STRUCTURAL DETAILS

S-501

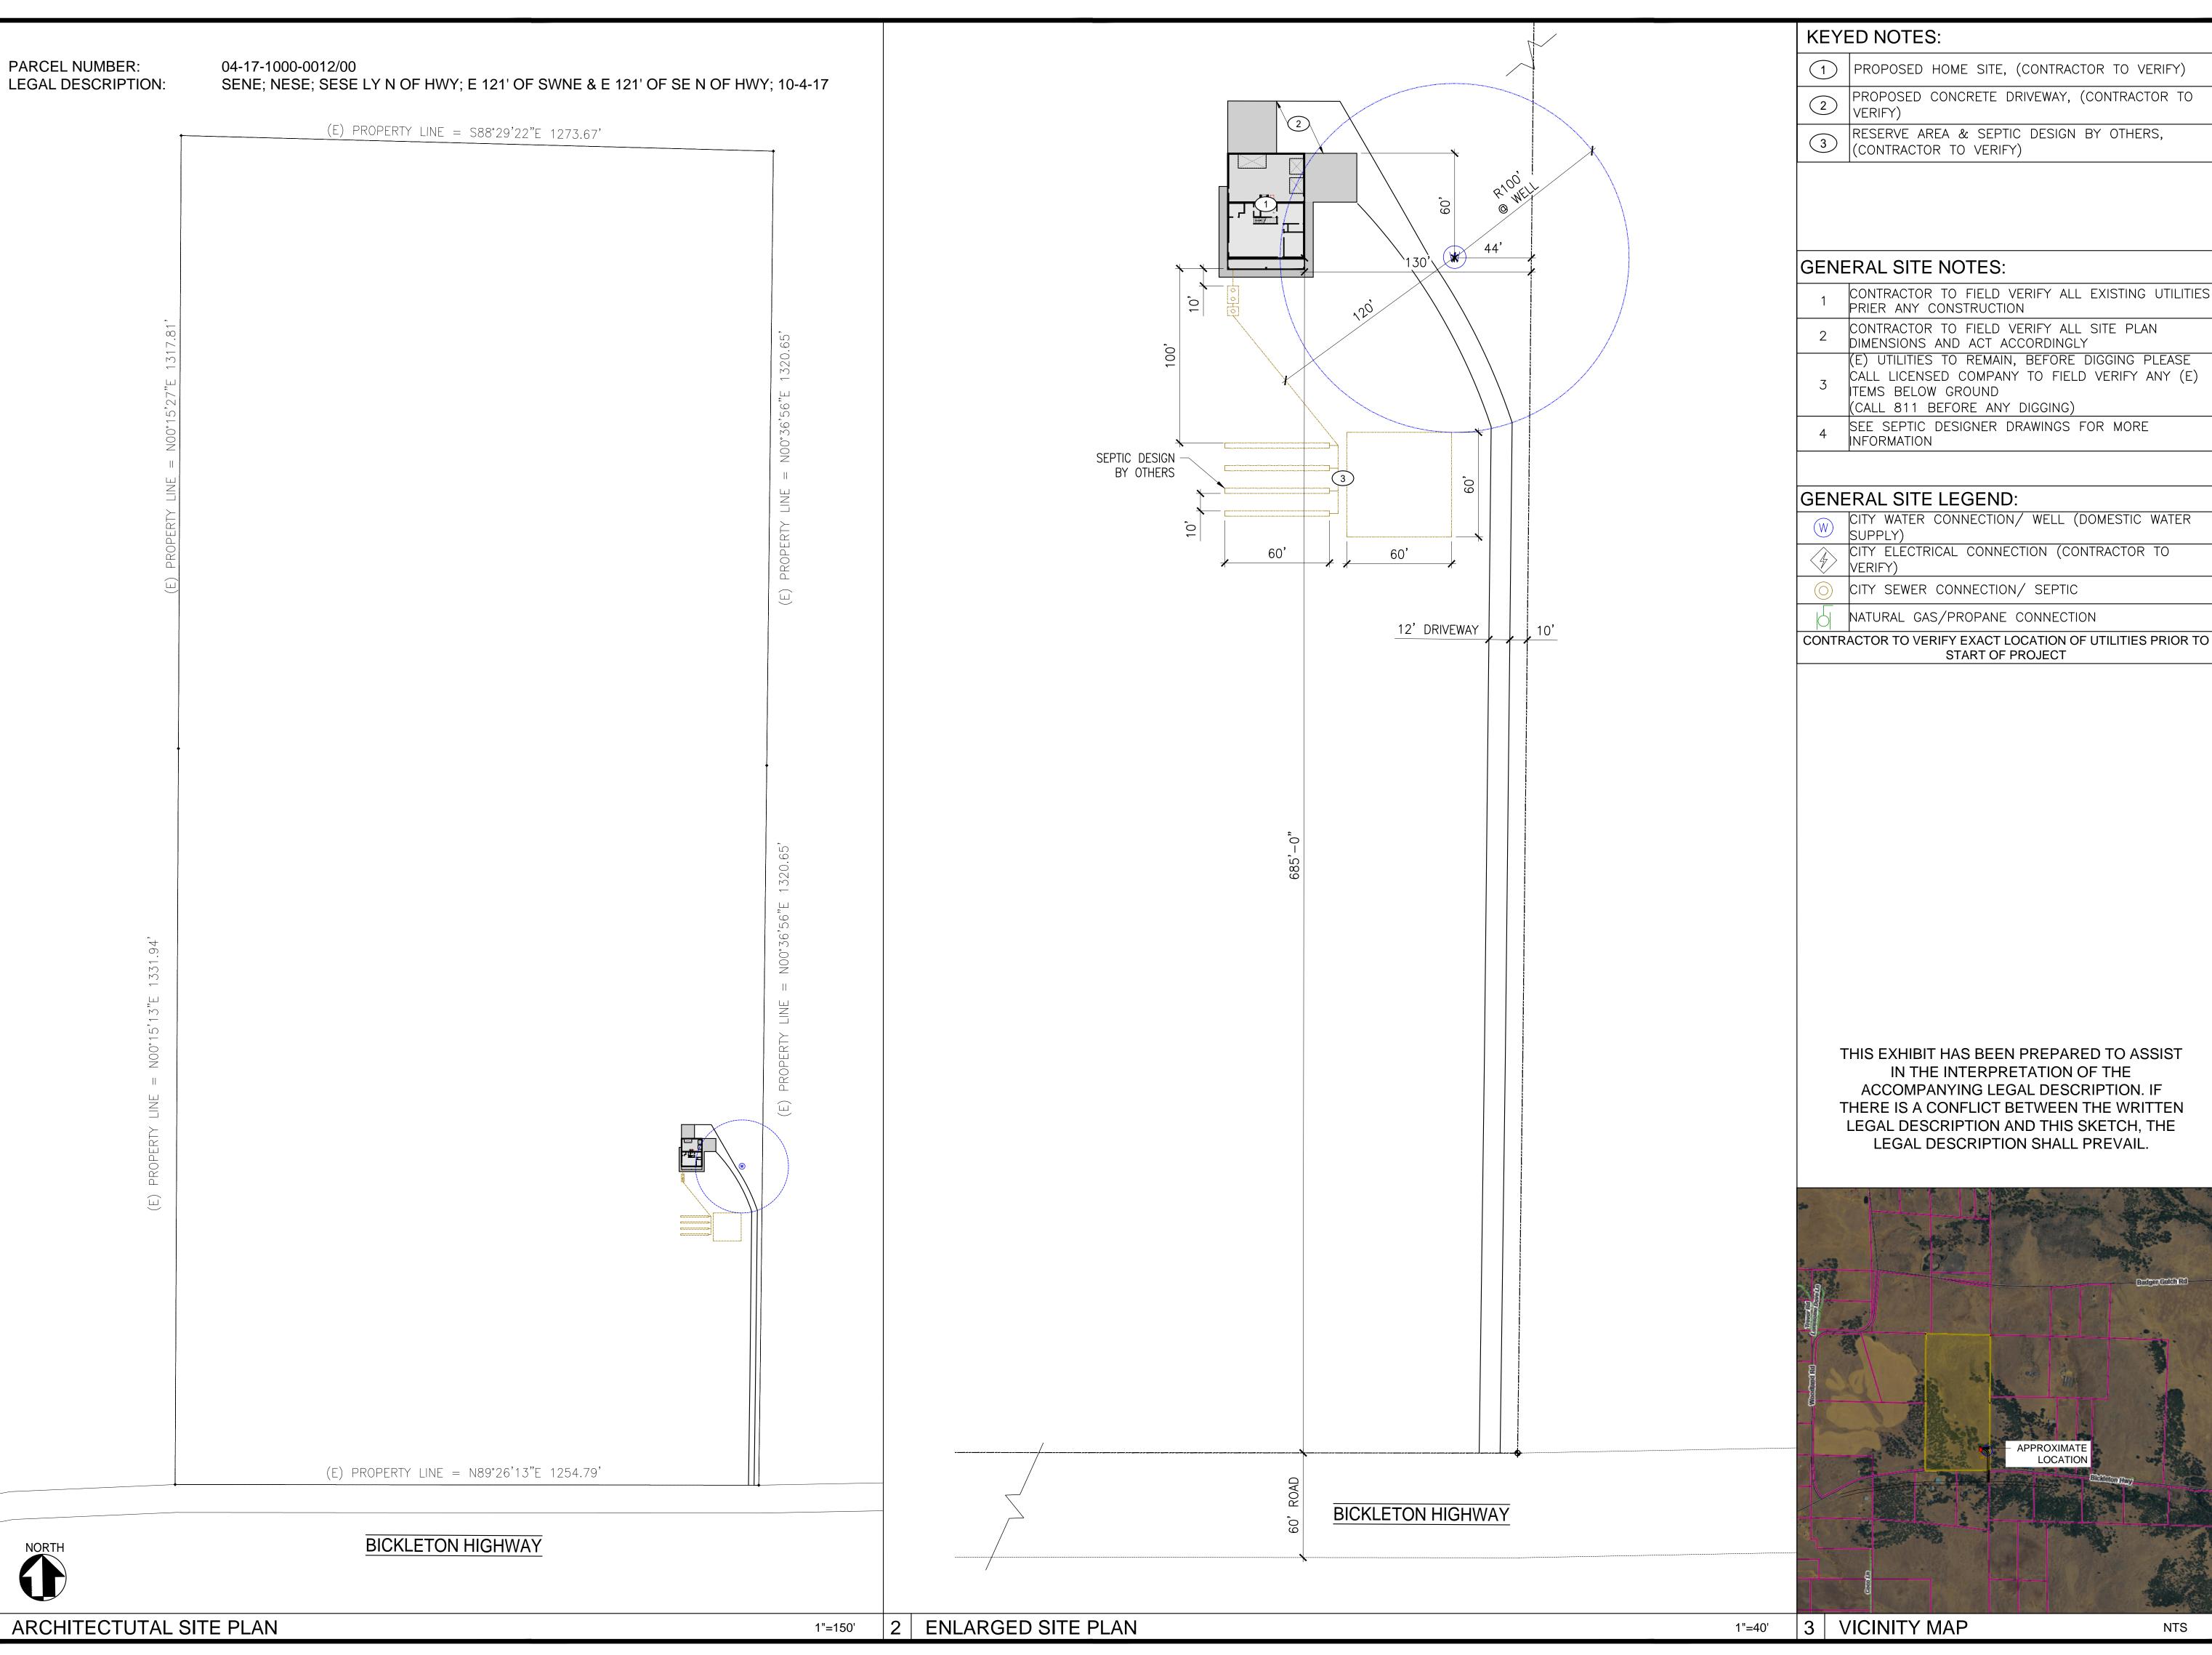

- PROPOSED HOME SITE, (CONTRACTOR TO VERIFY)
- PROPOSED CONCRETE DRIVEWAY, (CONTRACTOR TO
- RESERVE AREA & SEPTIC DESIGN BY OTHERS,

WEB: DRAFTCODESIGNS.COM

COMMERCIAL

4/11/2023 9:39:12 AM

MILENKO@DRAFTCODESIGNS.COM

RESIDENTIAL.

509.251.5939

BUILDING INFO: MAIN LEVEL 1368 SECOND LEVEL GARAGE 264 **COVERED ENTRY** LIVING SPACE NON-LIVING SPACE

TOTAL SCOPE


Job No. 22-161

COPYRIGHT NOTICE: USE OF THESE
PLANS WITHOUT EXPLICIT PERMISSION
OF DRAFTCO DESIGNS LLC AND
PAYMENT IS A COPYRIGHT VIOLATION
WHICH MAY SUBJECT THE USER TO
LIABILITY UNDER BOTH STATE AND

ARCH SITE PLAN

NTS

A-101

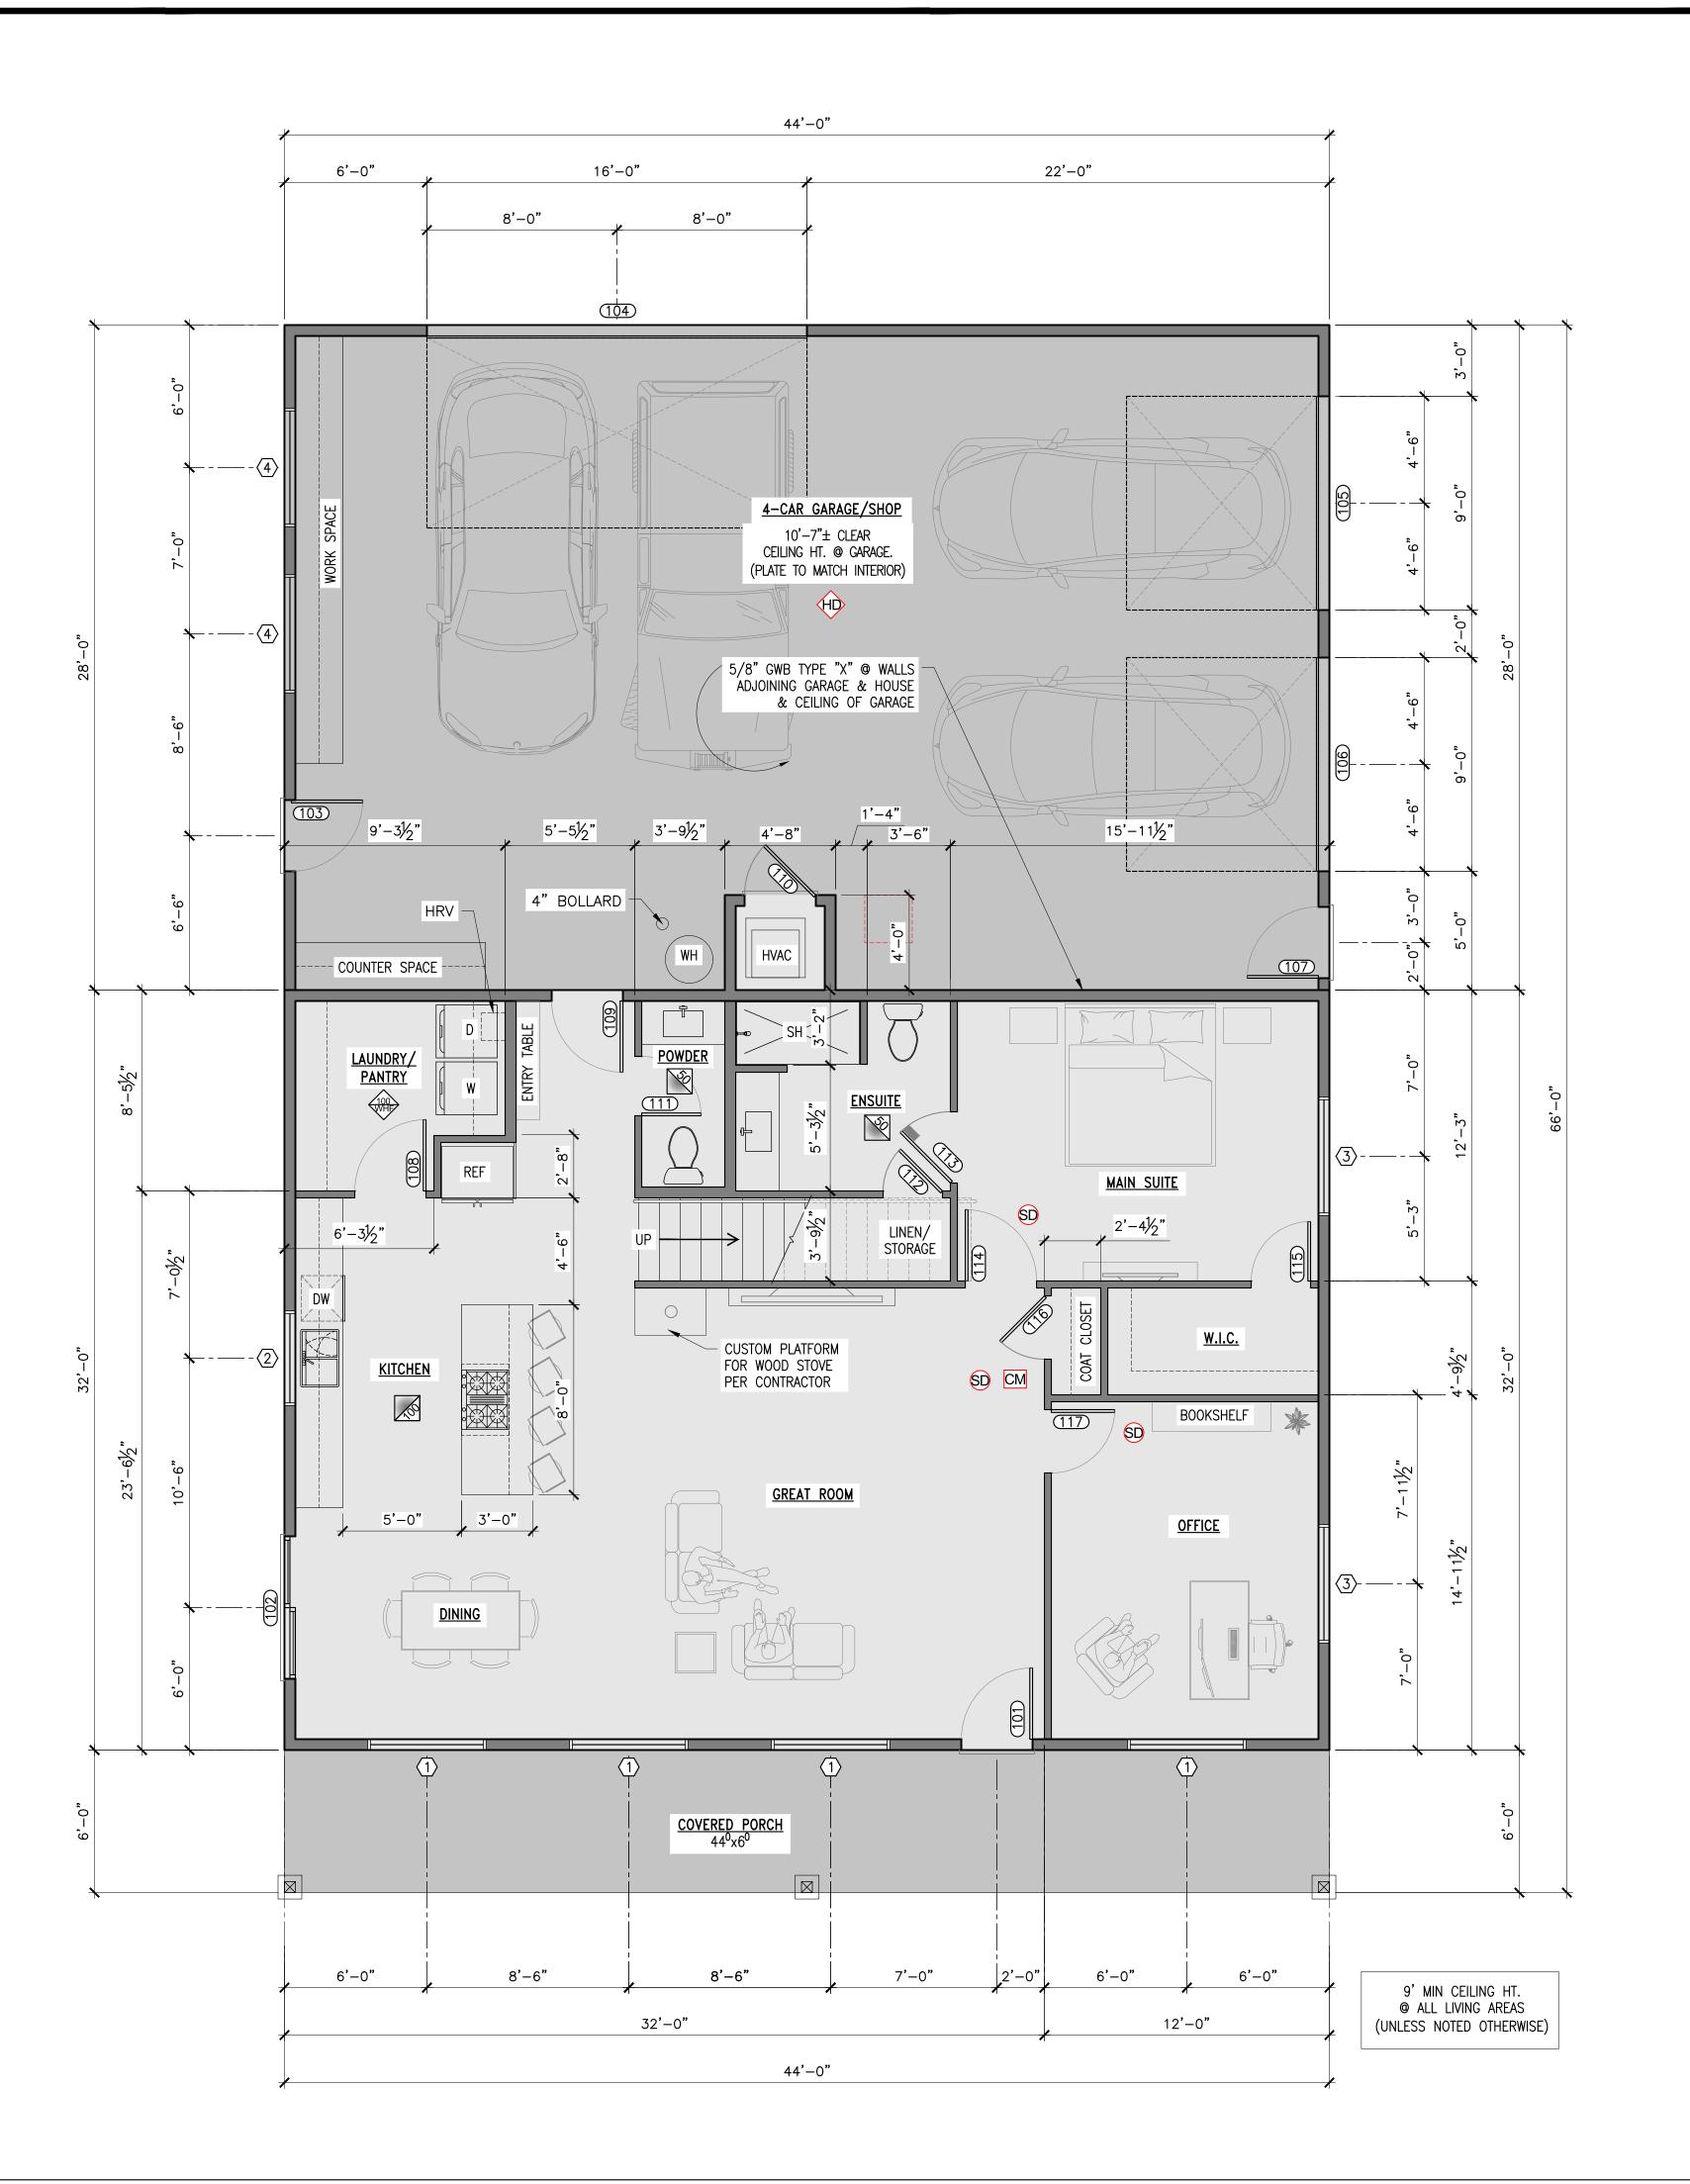

WINDOW SCHE					HEDULE
	WINDOW			MEET WA STATE ENERGY REQUIREMENTS, SAFETY GLAZING, SE	
	#	SIZE	QTY.	TYPE	REMARKS BELOW:
	1	5'-0"x5'-0"	6	FIXED	_
	2	4'-0"x4'-0"	1	SLIDER	_
	(3)	5'-0"x5'-0"	8	SLIDER	-
	4	5'-0"x2'-0"	2	FIXED	_
		TOTAL	17		

	DOOR SCHEDULE				
DOOR NO.	DOOR DIMENSIONS	FIRE RATING	LOCATION	REMARKS	
	SIZE				
101	3'-0"x6'-8"	_	ENTRY TO HOUSE	FRONT ENTRY DOO	
102	6'-0"x6'-8"	_	DINING ROOM — PATIO	GLASS SLIDER PE CONTRACTOR	
103	3'-0"x6'-8"	_	GARAGE - SIDE ENTRY	METAL INSULATED DOOR	
104	16'-0"x8'-0"	_	GARAGE	METAL INSULATED DOOR	
105	9'-0"x8'-0"	-	GARAGE	METAL INSULATED DOOR	
106	9'-0"x8'-0"	_	GARAGE	METAL INSULATED DOOR	
107	3'-0"x6'-8"	_	GARAGE - SIDE ENTRY	METAL INSULATED DOOR	
108	3'-0"x6'-8"	_	PANTRY	_	
109	3'-0"x6'-8"	20-MIN FIRE RATED	GARAGE — HOME	1¾" S.C. WOOD DOOR WITH SELF CLOSING HINGES	
110	3'-0"x6'-8"	20-MIN FIRE RATED	MECH	1¾" S.C. WOOD DOOR WITH SELF CLOSING HINGES	
111	2'-6"x6'-8"	_	POWDER	_	
112	2'-6"x6'-8"	_	ENSUITE - CLOSET	_	
113	3'-0"x6'-8"	_	ENSUITE	_	
114	3'-0"x6'-8"	_	MAIN SUITE	_	
115	2'-6"x6'-8"	_	W.I.C.		
116	2'-8"x6'-8"		COAT CLOSET	_	
117	2'-8"x6'-8"	_	OFFICE	<u> </u>	
201	3'-0"x6'-8"	_	COMMON SPACE	_	
202	3'-0"x6'-8"	_	BEDROOM #2	_	
203	3'-0"x6'-8"	_	CLOSET	DOUBLE DOOR	
204	2'-6"x6'-8"	_	ENSUITE	_	
205	2'-4"x6'-8"	_	W.I.C.	_	
206	2'-6"x6'-8"	_	BATH	_	
207	4'-0"x6'-8"	_	CLOSET	DOUBLE DOOR	
208	3'-0"x6'-8"	I	BEDROOM #3	<u>_</u>	

FLOOF	R PLAN LEGEND:
ITEM	DESCRIPTION
	2x STUD WALL, SEE WALL TYPES
X -	WALL TYPES
SD CM	INDICATES SMOKE DETECTOR & CARBO-MONOXIDE DEVICE PER MOST CURRENT CODE
$\langle X \rangle$	WINDOW CALLOUTS
(125)	DOOR CALLOUTS
HD	INTERCONNECTED HEAT DETECTOR
V	INDICATES 50CFM LIGHT/FAN COMBO
100	INDICATES 100CFM WHOLE HOUSE FAN
, so	INDICATES 100CFM LIGHT/FAN COMBO
\Diamond	INDICATES TEMPERED GLASS

FLOOR PLAN - NOTES:

- 1 CONTRACTOR TO FIELD VERIFY ALL CONDITIONS AND DIMENSIONS PRIOR TO BEGINNING CONSTRUCTION.
- ALL INTERIOR PARTITIONS, PENETRATIONS AND OTHER OPENINGS IN THE

 BUILDING SHALL BE SEALED GASKETED OR WEATHER STRIPPED AS
 REQUIRED TO MEET PARTITION RATINGS.
- 3 ALL DIMENSIONS ARE TO FACE OF STUD.
- 4 ALL ANGLED WALLS TO BE 45° UNLESS NOTED OTHERWISE
- CONTRACTOR TO VERIFY ALL DOOR AND WINDOW DIMENSIONS WITH OWNER BEFORE MAKING ANY ORDERS OR INSTALLATION, CONTACT DESIGNER FOR ANY NEEDED REVISIONS.
- NOTE: ALL GAS FIREPLACE HEATERS SHALL HAVE A MINIMUM FIREPLACE EFFICIENCY (FE) RATING OF NOT LESS THAN 50% IN ACCORDANCE WITH WSEC SECTION R402.4.2.1. THE FIREPLACE SHALL BE LISTED AND LABELED, INCLUDING THE FE RATINGS, IN ACCORDANCE WITH CSA P.4.1. ADDITIONALLY, PLEASE NOTE THAT THE FIREPLACE IS NOT PERMITTED TO BE EQUIPPED WITH A CONTINUOUSLY BURNING PILOT LIGHT PER WSEC SECTION

4/11/2023 9:39:36 AM

MILENKO@DRAFTCODESIGNS.COM WEB: DRAFTCODESIGNS.COM

509.251.5939

BUILDING INFO:

MAIN LEVEL

GARAGE

SECOND LEVEL

COVERED ENTRY

NON-LIVING SPACE

Job No. 22-161

LIVING SPACE

TOTAL SCOPE

COPYRIGHT NOTICE: USE OF THESE PLANS WITHOUT EXPLICIT PERMISSION OF DRAFTCO DESIGNS LLC AND PAYMENT IS A COPYRIGHT VIOLATION WHICH MAY SUBJECT THE USER TO LIABILITY UNDER BOTH STATE AND FEDERAL LAW. THE BUILDER/OWNER IS LICENSED A ONE-TIME USE OF THESE


PLANS. ALL PLANS ARE SITE SPECIFIC.

CUSTOM

MAIN LEVEL FLOOR PLAN

SHEET NO.:

-**∥** A-111

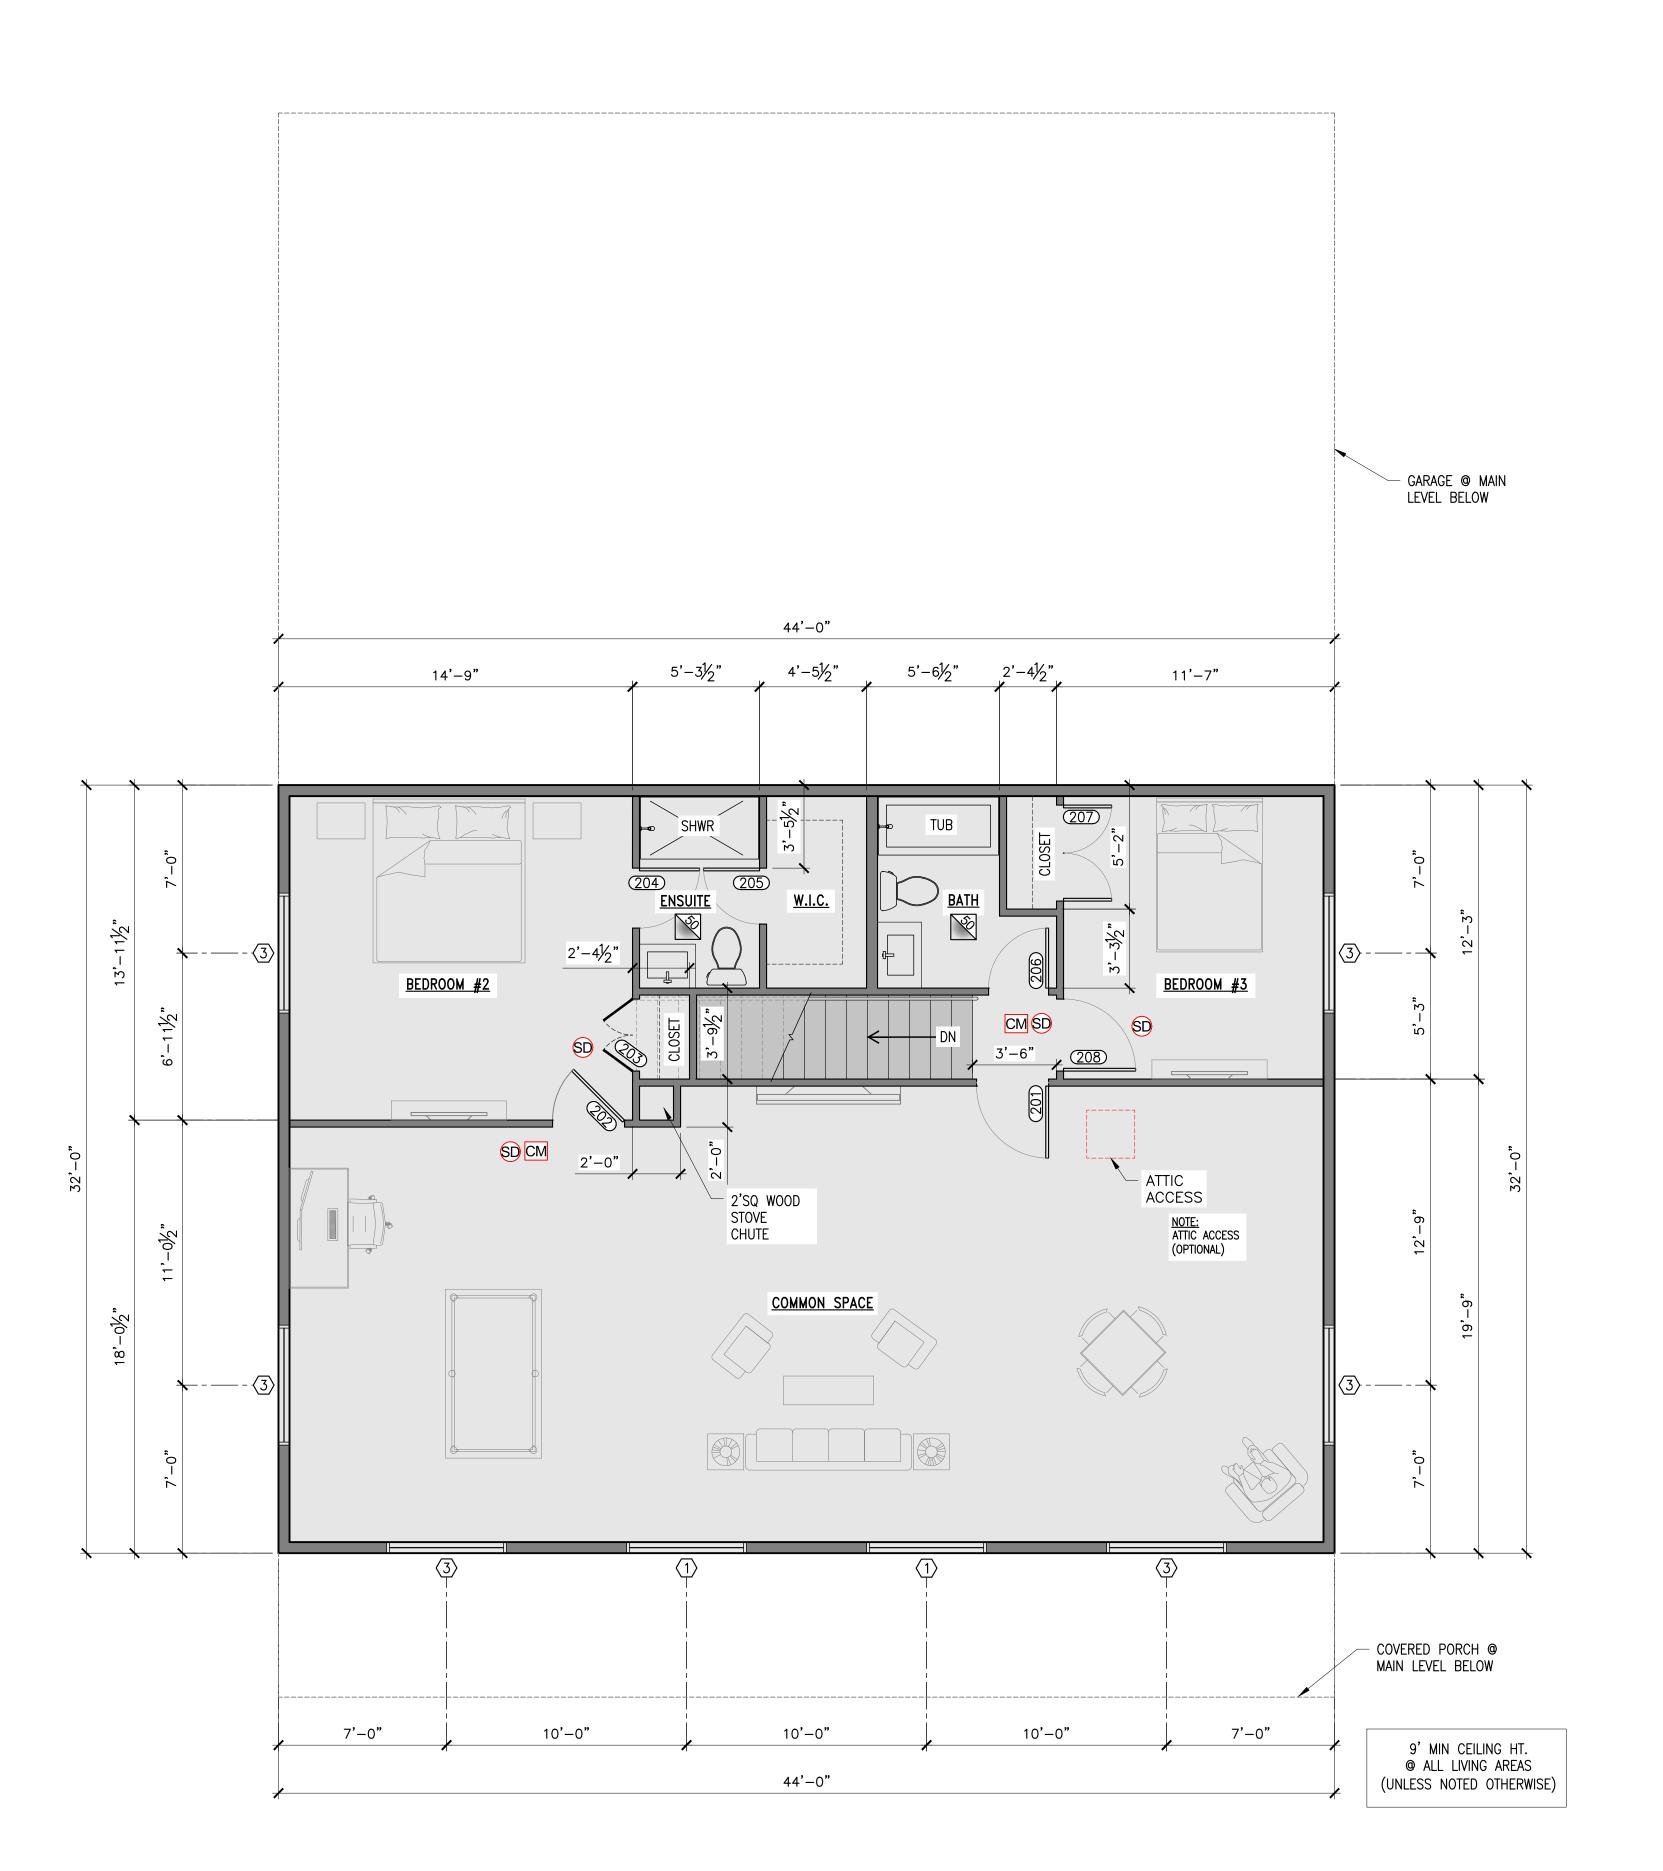

WINDOW SCHEDULE				
WINDOW				MEET WA STATE ENERGY REQUIREMENTS, SAFETY GLAZING, S
#	SIZE	QTY.	TYPE	REMARKS BELOW:
1	5'-0"x5'-0"	6	FIXED	_
2	4'-0"x4'-0"	1	SLIDER	_
3	5'-0"x5'-0"	8	SLIDER	_
4	5'-0"x2'-0"	2	FIXED	-
	TOTAL	17		

	DOOR SCHEDULE					
DOOR NO.	DOOR DIMENSIONS	FIRE LOCATION RE		REMARKS		
	SIZE					
101	3'-0"x6'-8"	_	ENTRY TO HOUSE	FRONT ENTRY DOOR		
102	6'-0"x6'-8"	-	DINING ROOM — PATIO	GLASS SLIDER PER CONTRACTOR		
103	3'-0"x6'-8"	_	GARAGE — SIDE ENTRY	METAL INSULATED DOOR		
104	16'-0"x8'-0"	-	GARAGE	METAL INSULATED DOOR		
105	9'-0"x8'-0"	_	GARAGE	METAL INSULATED DOOR		
106	9'-0"x8'-0"	_	GARAGE	METAL INSULATED DOOR		
107	3'-0"x6'-8"	_	GARAGE — SIDE ENTRY	METAL INSULATED DOOR		
108	3'-0"x6'-8"	_	PANTRY	_		
109	3'-0"x6'-8"	20-MIN FIRE RATED	GARAGE — HOME	1¾" S.C. WOOD DOOR WITH SELF CLOSING HINGES		
110	3'-0"x6'-8"	20-MIN FIRE RATED	MECH	1¾" S.C. WOOD DOOR WITH SELF CLOSING HINGES		
111	2'-6"x6'-8"	_	POWDER	_		
112	2'-6"x6'-8"	-	ENSUITE - CLOSET	1		
113	3'-0"x6'-8"	_	ENSUITE	_		
114	3'-0"x6'-8"	_	MAIN SUITE			
115	2'-6"x6'-8"	_	W.I.C.	_		
116	2'-8"x6'-8"	-	COAT CLOSET	_		
117	2'-8"x6'-8"	-	OFFICE	<u> </u>		
201	3'-0"x6'-8"	_	COMMON SPACE	_		
202	3'-0"x6'-8"	_	BEDROOM #2	_		
203	3'-0"x6'-8"	_	CLOSET	DOUBLE DOOR		
204	2'-6"x6'-8"	_	ENSUITE	_		
205	2'-4"x6'-8"	_	W.I.C.	_		
206	2'-6"x6'-8"	_	BATH	_		
207	4'-0"x6'-8"	_	CLOSET	DOUBLE DOOR		
208	3'-0"x6'-8"	_	BEDROOM #3	_		

FLOOF	R PLAN LEGEND:
ITEM	DESCRIPTION
	2x STUD WALL, SEE WALL TYPES
X -	WALL TYPES
SD CM	INDICATES SMOKE DETECTOR & CARBO-MONOXIDE DEVICE PER MOST CURRENT CODE
$\langle \chi \rangle$	WINDOW CALLOUTS
(125)	DOOR CALLOUTS
HD	INTERCONNECTED HEAT DETECTOR
É	INDICATES 50CFM LIGHT/FAN COMBO
100 WHI	INDICATES 100CFM WHOLE HOUSE FAN
, so	INDICATES 100CFM LIGHT/FAN COMBO
\Diamond	INDICATES TEMPERED GLASS

П	OOR	ח	Λ N I	NIC	\TC	<u> </u>
- I	()()()()()()()()()()()()()()()()()()()	РΙ	AIN	- 1/1() I 🗀	٠.

CONTRACTOR TO FIELD VERIFY ALL CONDITIONS AND DIMENSIONS PRIOR TO BEGINNING CONSTRUCTION.

ALL INTERIOR PARTITIONS, PENETRATIONS AND OTHER OPENINGS IN THE BUILDING SHALL BE SEALED GASKETED OR WEATHER STRIPPED AS REQUIRED TO MEET PARTITION RATINGS.

3 ALL DIMENSIONS ARE TO FACE OF STUD.

4 ALL ANGLED WALLS TO BE 45° UNLESS NOTED OTHERWISE CONTRACTOR TO VERIFY ALL DOOR AND WINDOW DIMENSIONS WITH

OWNER BEFORE MAKING ANY ORDERS OR INSTALLATION, CONTACT DESIGNER FOR ANY NEEDED REVISIONS. NOTE: ALL GAS FIREPLACE HEATERS SHALL HAVE A MINIMUM FIREPLACE EFFICIENCY (FE) RATING OF NOT LESS THAN 50% IN ACCORDANCE WITH WSEC SECTION R402.4.2.1. THE

FIREPLACE SHALL BE LISTED AND LABELED, INCLUDING THE FE RATINGS, IN ACCORDANCE WITH CSA P.4.1. ADDITIONALLY, PLEASE NOTE THAT THE FIREPLACE IS NOT PERMITTED TO BE EQUIPPED WITH A CONTINUOUSLY BURNING PILOT LIGHT PER WSEC SECTION

4/11/2023 9:38:55 AM

MILENKO@DRAFTCODESIGNS.COM WEB: DRAFTCODESIGNS.COM

509.251.5939

BUILDING INFO:				
MAIN LEVEL	1427			
SECOND LEVEL	1368			
GARAGE	1213			
COVERED ENTRY	264			
IVING SPACE	2795			
ION-LIVING SPACE	1477			
OTAL SCOPE	4272			

Job No. 22-161

COPYRIGHT NOTICE: USE OF THESE
PLANS WITHOUT EXPLICIT PERMISSION
OF DRAFTCO DESIGNS LLC AND
PAYMENT IS A COPYRIGHT VIOLATION WHICH MAY SUBJECT THE USER TO LIABILITY UNDER BOTH STATE AND FEDERAL LAW. THE BUILDER/OWNER IS LICENSED A ONE-TIME USE OF THESE PLANS. ALL PLANS ARE SITE SPECIFIC.

> SECOND LEVEL FLOOR PLAN

SHEET NO.:



4/11/2023 9:39:19 AM

MILENKO@DRAFTCODESIGNS.COM WEB: DRAFTCODESIGNS.COM

> FTCO AS LLC

RESIDENTIAL-COMMI

509.251.5939

BUILDING INFO:				
MAIN LEVEL	1427			
SECOND LEVEL	1368			
GARAGE	1213			
COVERED ENTRY	264			
LIVING SPACE	2795			
NON-LIVING SPACE	1477			
TOTAL SCOPE	4272			
The state of the s				

Job No. 22-161

1/4"=1'


LOWE RESIDENCE
CUSTOM HOME
781 BICKLETON HWY
GOI DENDALE WA 98620

COPYRIGHT NOTICE: USE OF THESE PLANS WITHOUT EXPLICIT PERMISSION OF DRAFTCO DESIGNS LLC AND PAYMENT IS A COPYRIGHT VIOLATION WHICH MAY SUBJECT THE USER TO LIABILITY UNDER BOTH STATE AND FEDERAL LAW. THE BUILDER/OWNER IS LICENSED A ONE-TIME USE OF THESE PLANS. ALL PLANS ARE SITE SPECIFIC.

BUILDING ELEVATIONS

SHEET NO.:
A-201

FRONT ELEVATION

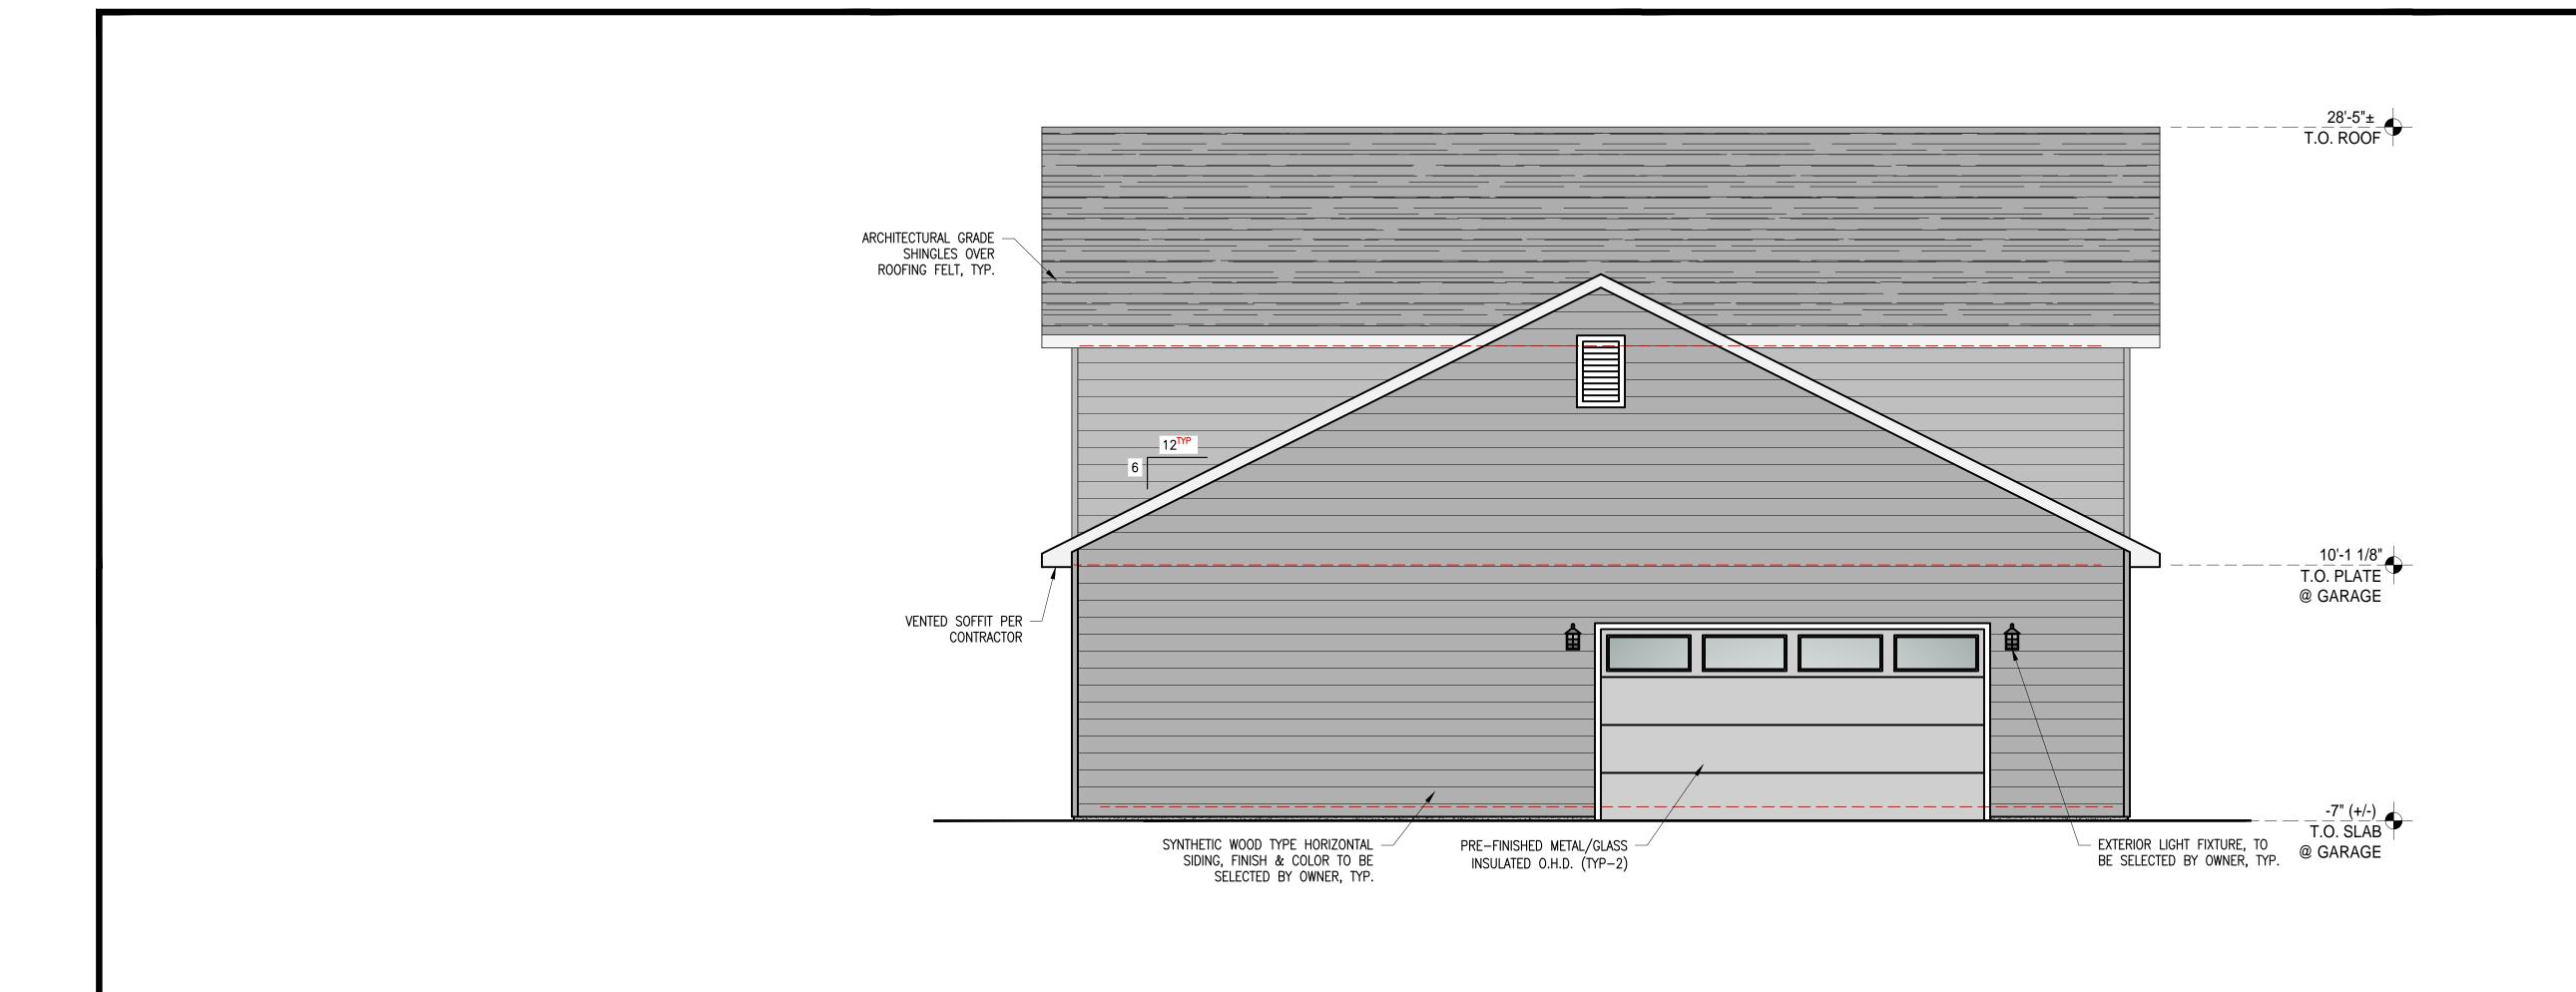

4/11/2023 9:39:44 AM

MILENKO@DRAFTCODESIGNS.COM WEB: DRAFTCODESIGNS.COM

> CO LLC

DESIGNS I

509.251.5939

BUILDING INFO:				
MAIN LEVEL	1427			
SECOND LEVEL	1368			
GARAGE	1213			
COVERED ENTRY	264			
LIVING SPACE	2795			
NON-LIVING SPACE	1477			
TOTAL SCOPE	4272			

Job No. 22-161

1/4"=1'

WE RESIDENCE
CUSTOM HOME
781 BICKLETON HWY

COPYRIGHT NOTICE: USE OF THESE PLANS WITHOUT EXPLICIT PERMISSION OF DRAFTCO DESIGNS LLC AND PAYMENT IS A COPYRIGHT VIOLATION WHICH MAY SUBJECT THE USER TO LIABILITY UNDER BOTH STATE AND FEDERAL LAW. THE BUILDER/OWNER IS LICENSED A ONE-TIME USE OF THESE PLANS. ALL PLANS ARE SITE SPECIFIC.


BUILDING ELEVATIONS

A-202

BACK ELEVATION

TO SIDE

TO SI

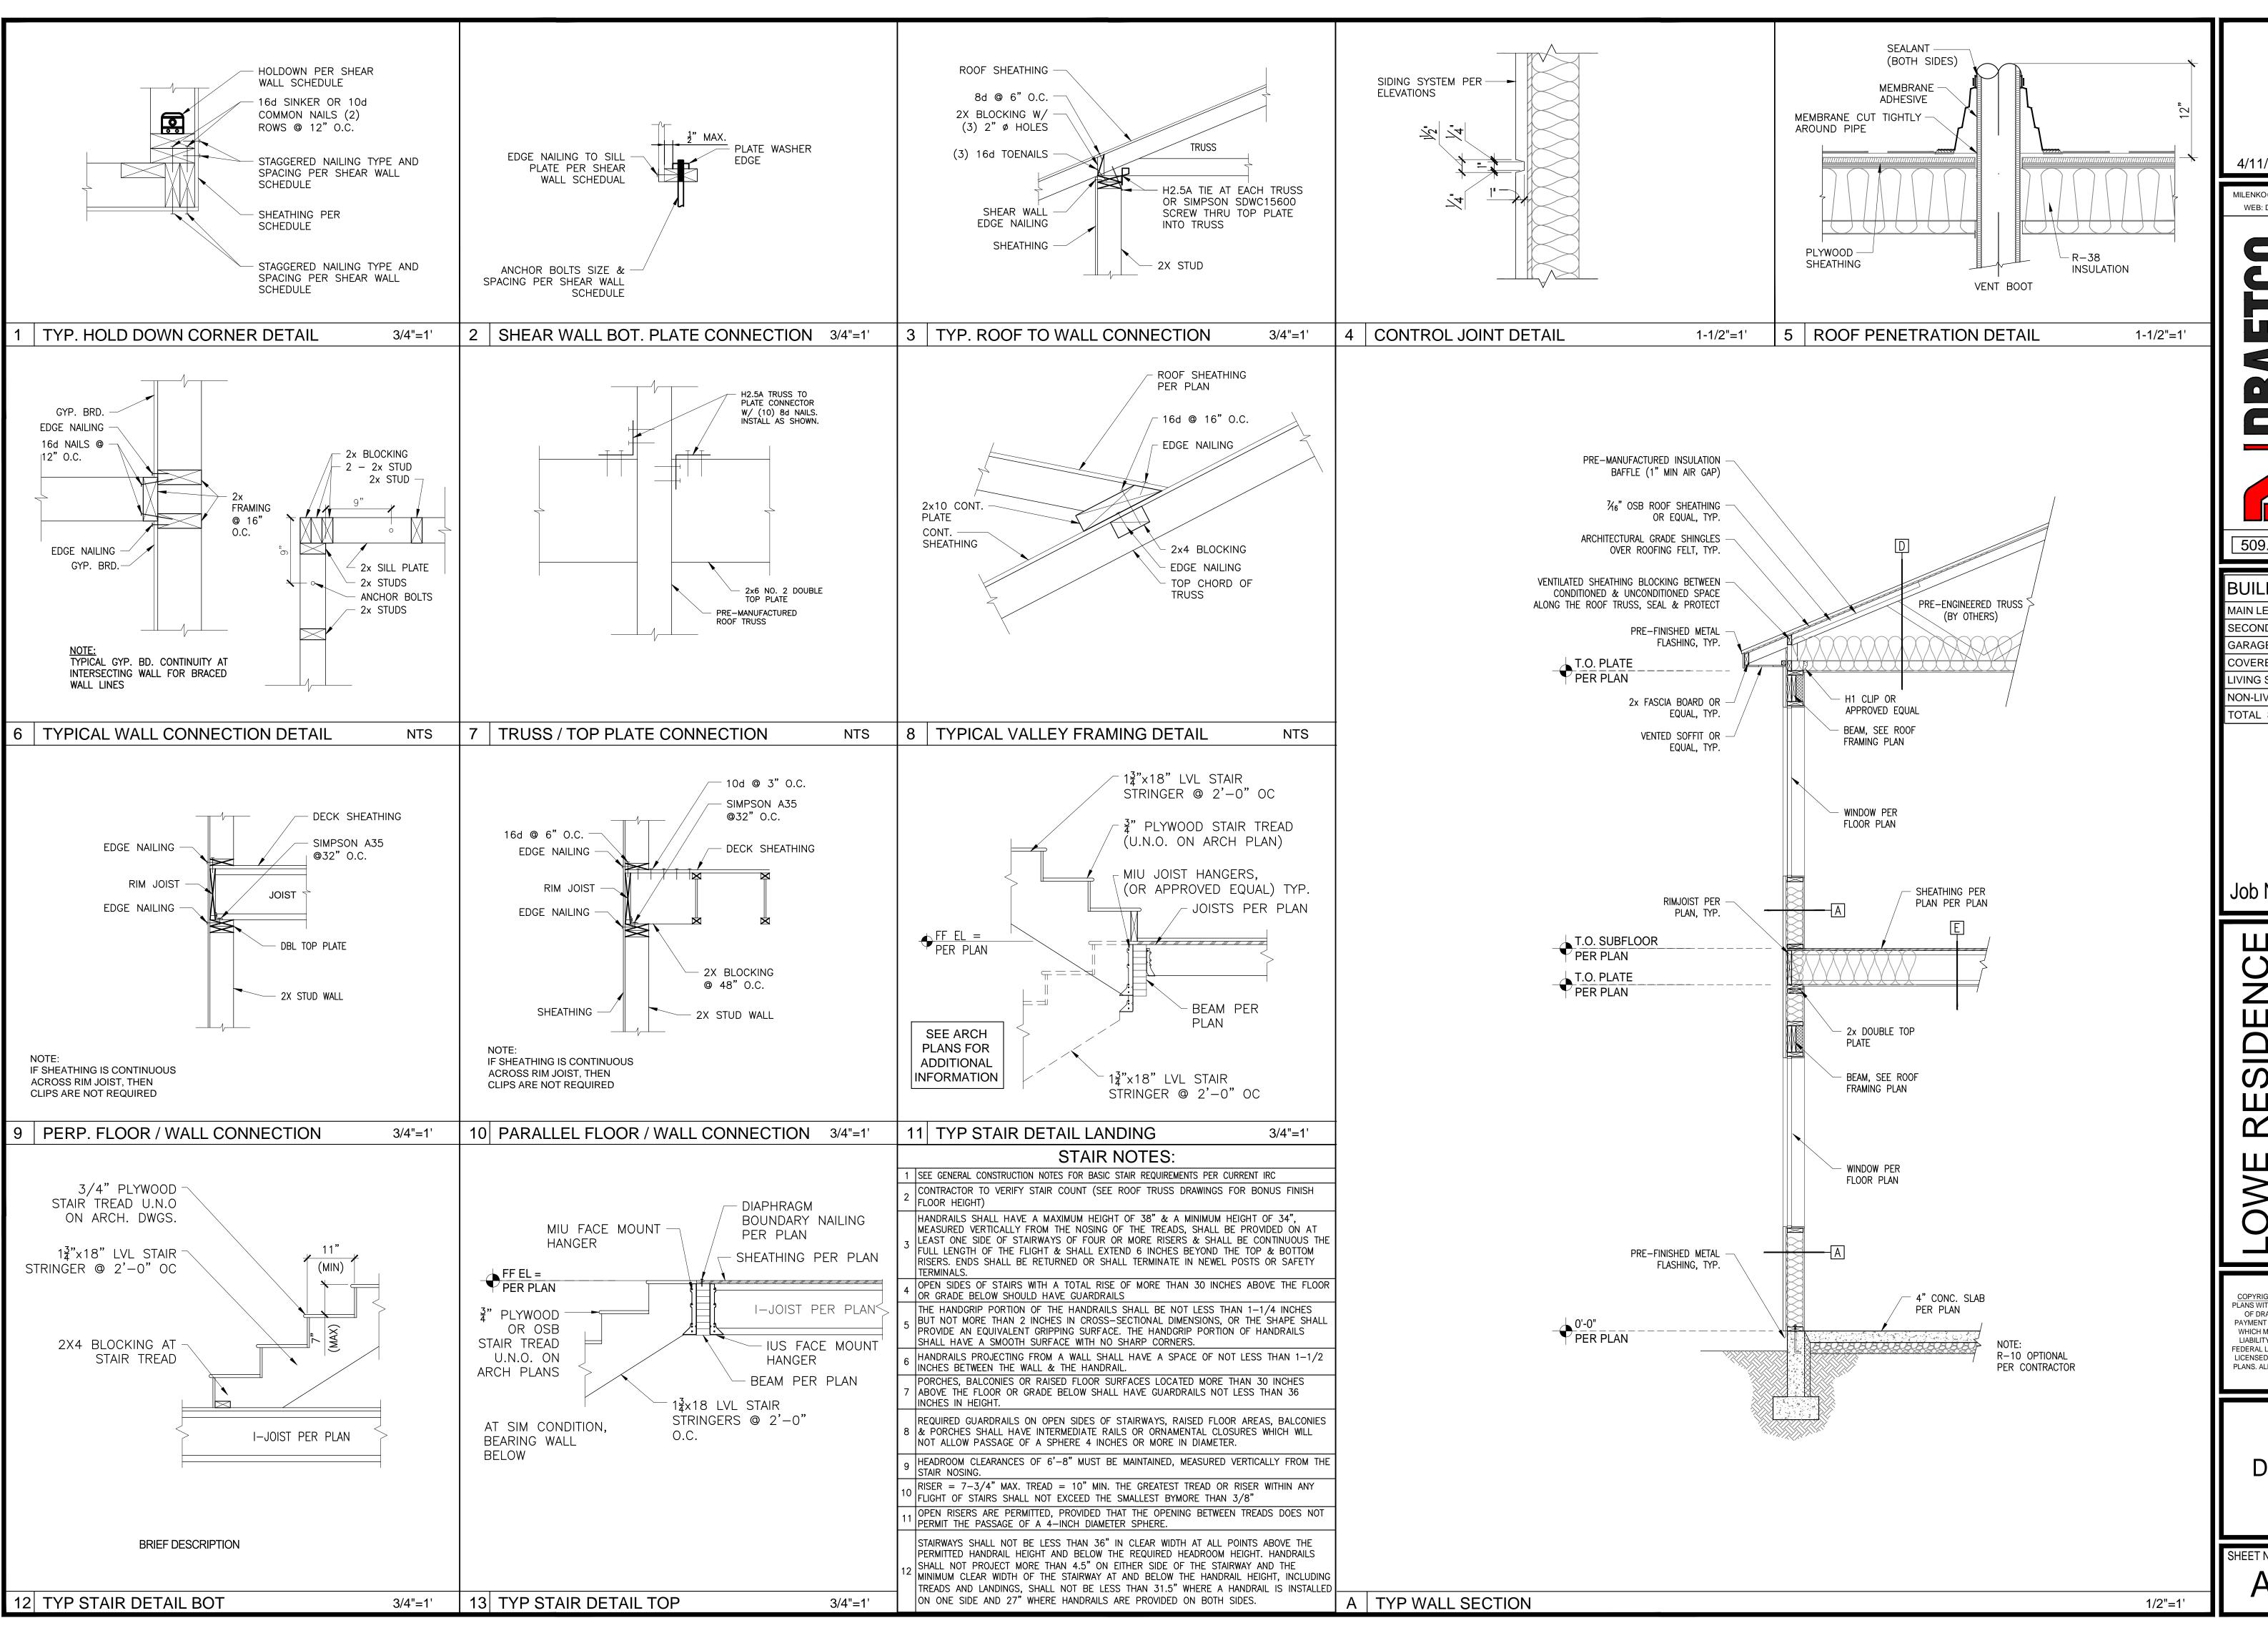

4/11/2023 9:39:48 AM

MILENKO@DRAFTCODESIGNS.COM WEB: DRAFTCODESIGNS.COM

OMMERCIA

RESIDE

509.251.5939

BUILDING INFO:					
IAIN LEVEL	1427				
SECOND LEVEL	1368				
SARAGE	1213				
OVERED ENTRY	264				
IVING SPACE	2795				
ION-LIVING SPACE	1477				
OTAL SCOPE	4272				

Job No. 22-161

HOME STOM CC

COPYRIGHT NOTICE: USE OF THESE PLANS WITHOUT EXPLICIT PERMISSION OF DRAFTCO DESIGNS LLC AND PAYMENT IS A COPYRIGHT VIOLATION WHICH MAY SUBJECT THE USER TO LIABILITY UNDER BOTH STATE AND FEDERAL LAW. THE BUILDER/OWNER IS LICENSED A ONE-TIME USE OF THESE PLANS. ALL PLANS ARE SITE SPECIFIC

DETAILS

A-501

2018 Washington State Energy Code - Residential

Prescriptive Energy Code Compliance for All Climate Zones in Washington
Single Family - New & Additions (effective February 1, 2021)

These requirements apply to all IRC building types, including detached one- and two-family dwellings and multiple single family dwellings (townhouses)

INSTRUCTIONS:

This single-family project will use the requirements for the Prescriptive Path below and incorporate the minimum values listed.

Based on the size of the structure, the appropriate number of additional credits are checked as chosen by the permit applicant.

Provide all information from the following tables as building permit drawings: Table R402.1 - Insulation and Fenestration

Requirments by Component, Table R406.2 - Fuel Normalization Credits and 406.3 - Energy Credits.

		All Climate Zones (Table R402.1.1)	
		R-Value [a]	U-Factor [a]
Fenest	ration U-Factor [b]	n/a	0.30
Skyl	ight U-Factor [b]	n/a	0.50
Glazed Fe	nestration SHGC [b,e]	n/a	n/a
	Ceiling [e]	49	0.026
Wood Frame Wall [g,h] Floor Below Grade Wall [c,h]		21 int	0.056
		30	0.029
		v Grade Wall [c,h] 10/15/21 int + TB	
Slab [d,	f] R-Value & Depth	10, 2 ft	n/a
[a]	that is less than the lab	s. U-factors and SHGC are maximums. When i rel or design thickness of the insulation, the c dix Table A101.4 shall not be less than the R-v	compressed R-value of the
[b]	The fenestration U-fact	tor column excludes skylights.	
	The second secon	s R-10 continuous insulation on the exterior of the wall, or R-21 cavity insulation plus a	

continuous insulation on the interior or exterior of the wall. "5TB" means R-5 thermal break between floor slab and basement wall.

[d] R-10 continuous insulation is required under heated slab-on-grade floors. See Section R402.2.9.1.

For single rafter or joist-vaulted ceilings, the insulation may be reduced to R- 38 if the full insulation

slab and the basement wall at the interior of the basement wall. "10/15/21 + 5TB" shall be permitted to be met with R-13 cavity insulation on the interior of the basement wall plus R-5

depth extends over the top plate of the exterior wall.

R-7.5 continuous insulation installed over an existing slab is deemed to be equivalent to the required perimeter slab insulation when applied to existing slabs complying with Section R503.1.1. If foam plastic is used, it shall meet the requirements for thermal barriers protecting foam plastics.

For log structures developed in compliance with Standard ICC 400, log walls shall meet the requirements for climate zone 5 of ICC 400.

Int. (intermediate framing) denotes framing and insulation as described in Section A103.2.2
[h] including standard framing 16 inches on center, 78 percent of the wall cavity insulated and headers insulated with a minimum of R-10 insulation.

Each dwelling unit in a residential building shall comply with sufficient options from Table R406.2 (fuel normalization credits) and Table 406.3 (energy credits) to achieve the following minimum number of credits. To claim this credit, this sheet shall be provided within the building permit drawings, and shall specify the option(s) selected, the maximum tested building air leakage, and show the qualifying ventilation system and its control sequence of operation.

- 1. Small Dwelling Unit: 3 Credits
- Dwelling units less than 1,500 sf in conditioned floor area with less than 300 sf of fenestration area.

 Additions to existing buildings that are greater than 500 sf of heated floor area but less than 1,500sf.
- 2. Medium Dwelling Unit: 6 Credits
- All dwelling units that are not included in #1 or #3.

 3. Large Dwelling Unit: 7 Credits
- Dwelling units exceeding 5,000 sf of conditioned floor area.
- Additions less than 500 sf: 1.5 Credits
 All other additions shall meet 1-3 above.

Before selecting your credits on this Summary table, review the details in Table 406.3 of the WSEC-R.

	Summary of Table R406.2						
Heating Option	Fuel Normalization Descriptions	Credits - Select ONE heating option		Heating Unit Type (i.e. heat pump, gas furnace, etc.)			
1	Combustion heating equipment [b]	0.0					
2	Heat pump [c]	1.0	>				
3	Electric resistance heat only, furnace or zona	-1.0					
4	DHP w/zonal elec. Resistance per Option 3.4	0.5					
5	All other heating systems	-1.0					

Energy Option	Energy Credit Descriptions	ns Credits - Select ONE heating option		System Make & Model Number
1.1	Efficient Building Envelope	0.5		
1.2	Efficient Building Envelope	1.0		
1.3	Efficient Building Envelope	0.5		
1.4	Efficient Building Envelope	1.0		
1.5	Efficient Building Envelope	2.0		
1.6	Efficient Building Envelope	3.0		
1.7	Efficient Building Envelope	0.5		
2.1	Air Leakage Control and Efficient Ventilation	0.5		
2.2	Air Leakage Control and Efficient Ventilation	1.0	V	
2.3	Air Leakage Control and Efficient Ventilation	1.5		
2.4	Air Leakage Control and Efficient Ventilation	2.0		
3.1 [a]	High Efficiency HVAC	1.0		
3.2	High Efficiency HVAC	1.0	V	
3.3 [a]	High Efficiency HVAC	1.5		
3.4	High Efficiency HVAC	1.5		
3.5	High Efficiency HVAC	1.5		
3.6 [a]	High Efficiency HVAC	2.0		
4.1	High Efficiency HVAC Distribution System	0.5		
4.2	High Efficiency HVAC Distribution System	1.0	>	

Energy Option	Energy Credit Descriptions	Credits - Select ONE heating option		System Make & Model Number
5.1 [d]	Efficient Water Heating	0.5		
5.2	Efficient Water Heating	0.5		
5.3	Efficient Water Heating	1.0		
5.4	Efficient Water Heating	1.5		
5.5	Efficient Water Heating	2.0	V	
5.6	Efficient Water Heating	2.5		
6.1 [e]	Renewable Electric Energy (3 credits max)	1.0	0	Enter 0-3 Credits
7.1	Appliance Package	0.5		
	Total Credits		6	

[a]	An alternative heating source sized at a maximum of 0.5 Watts/ft2 (equivalent) of heated floor area or 500 Watts, whichever is bigger, may be installed in the dwelling unit.
[b]	Meeting minimum federal efficiency standards for the equipment listed in Table C403.3.2(4) or C403
[c]	Equipment listed in Table C403.3.2(1)C or C403.3.2(2)
۲۹۱	You cannot select more than one option from any category EXCEPT in category 5, where Option 5.1
լսյ	You cannot select more than one option from any category EXCEPT in category 5, where Option 5.1 may be combined with Options 5.2 through 5.6. See Table 406.3.
[e]	1.0 credit for each 1,200 kWh of electrical generation provided annually, up to 3 credits max. See the complete Table R406.2 for all requirements and option descriptions.

	Vaulted R- /		R-	
Ceiling/Attic	Attic R-		R-	
	.,	Doors	R-	
	Above grade R-		R-	
Walls	Below, Interior R- /			
	Below, Exterior R-	Windows	Windows Area weighted, U-	
	Over uncon. space R-	Air	Leakage Control	
Floors	Slab-on-grade R-	Tested Air Leakage	Target ACH-50	
	Fully insulated slab		Conditioned Floor Area	

	Tany modrated order	conditioned 1 look / lied
ne 100 100 100 100 100 100 100 100 100 10	ſ	
Designer Notes		

Window, Skylight, and Door Schedule									
Exempt Fenestrations									
	Ref.	U-Factor	Quantity	Width (in)	Height (in)	Area	UA		
Exempt Swinging Door (24sf max)						0.0	0.00		
Exempt Glazed Fenestration (15sf max)						0.0	0.00		
Ver	rtical Fenestratio								
Component Description	Ref.	U-Factor	Quantity	Width (in)	Height (in)	Area	UA		
WINDOW TYPE 1		0.3		AT 93-4		150.0	45.00		
WINDOW TYPE 2		0.3	1	48	48	16.0	4.80		
WINDOW TYPE 3		0.3	8	60	60	200.0	60.00		
						0.0	0.00		
DOOR 101		0.3	1	. 36	80	20.0	6.00		
DOOR 102		0.3	1	. 72	80	40.0	12.00		
DOOR 109		0.3	1	. 36	80	20.0	6.00		
						0.0	0.00		
						0.0	0.00		
		+ 1				0.0	0.00		
					7	0.0	0.00		
		+				0.0	0.00		
		+				0.0	0.00		
		+	l.		"	0.0	0.00		
						0.0	0.00		

Ove	rhead Gla	zing (Skyligl	hts)				
Component Description	Ref.	U-Factor	Quantity	Width (in)	Height (in)	Area	UA
						0.0	0.0
						0.0	0.0
						0.0	0.0
						0.0	0.0
						0.0	0.0
						0.0	0.0
		Sum	of Overhea	ıd Glazing A	rea and UA	0.0	0.0
		Overhea	d Glazing A	rea Weight	ed U-value		#DIV/0
Total Sum of Fenestration	on Area ai	nd UA (for h	e ating syste	em sizing co	alculations)	446.0	133.8

Sum of Vertical Fenestration Area and UA

Vertical Fenestration Area Weighted U-value

Simple Heating System Size: Washington State

This heating system sizing calculator is based on the Prescriptive Requirements of the 2018 Washington State Energy Code (WSEC) and ACCA Manuals J and S. This tool will calculate heating loads only. ACCA procedures for sizing cooling systems should be used to determine cooling loads.

Please complete the green drop-downs and boxes that are applicable to your project. As you make selections in the drop-downs for each section, some values will be calculated for you. If you do not see the selection you need in the drop-down options, please contact the WSU Energy Program at energycode@energy.wsu.edu or (360) 956-2042 for assistance.

Project Information			Contact Information					
LOWE RESIDENCE			DRAFTCO DESIGNS LLC					
781 BICKLETON HWY			8458 W GAGE	BLV	D			
GOLDENDALE, WA 98620			KENNEWICK	WA 9	99336			
Heating System Typ	O All Other Systems	•	Heat Pump					
To see detailed instructions	for each section, place your cui	rsor on the w	ord "Instructions	"				
Design Temperature	9							
Instructions Goldendale			Design Temperature Difference (Δ T) Δ T = Indoor (70 degrees) - Outdoor Design Temp					63
			$\Delta I = Indoor (7)$	0 deg	rees) - Outdoor	Desig	n lemp	
Area of Building								
Conditioned Floor	rea			1				
Instructions	nditioned Floor Area (sq ft)		2,795					
Average Ceiling Height					Conditione	d Vol	ume	
Instructions Ave	rage Ceiling Height (ft)		9.0		25,155			
Glazing and Doors			U-Factor	X	Area	_=	UA	
Instructions	J-0.28		0.280		446		124.88	
The state of the s				v	1150,000			
Skylights Instructions			U-Factor 0.50	X	Area	=	UA 	
			0.50	L				
Insulation Attic			U-Factor	v	Aros		IIA	
Instructions			0.026	X	Area 1,368	-	UA 35.57	
	R-49	·	0.026	į.	1,300		33.37	
Single Rafter or Joi	st Vaulted Ceilings		U-Factor	X	Area	_	UA	
Instructions	Select R-Value		No selection	,				
Above Grade Walls	(coo Figure 4)		U-Factor	х	Area		UA	
Instructions	R-21 Intermediate	•	0.056	^ [2,290	1	128.24	
	C-21 Intermediate		0.000	1				
Floors			U-Factor	X	Area	1	UA	
Instructions	Select R-Value		No selection					
Below Grade Walls	(see Figure 1)		U-Factor	х	Area		UA	
Instructions	Select R-value		No selection					
						_		
Slab Below Grade (see Figure 1)			F-Factor	X	Length	1	UA	
ilistructions	No Slab Below Grade in this project.	*	0.303	l				
Slab on Grade (see F	igure 1)		F-Factor	х	Length		UA	
Instructions	R-10 Perimeter		0.540		152		82.08	
						n)		
Location of Ducts								
Instructions	Conditioned Space		Duct Leakage Coefficient					
		The second second			1.00			

370.77 Sum of UA Envelope Heat Load 23,358 Btu / Hour Sum of UA $\times \Delta T$ Air Leakage Heat Load 17,115 Btu / Hour Volume x 0.6 x ΔT x 0.018 **Building Design Heat Load** 40,474 Btu / Hour Air leakage + envelope heat loss **Building and Duct Heat Load** 40,474 Btu / Hour Ducts in unconditioned space: sum of building heat loss x 1.10 Ducts in conditioned space: sum of building heat loss x 1 Maximum Heat Equipment Output 50,592 Btu / Hour Building and duct heat loss x 1.40 for forced air furnace

Building and duct heat loss x 1.25 for heat pump





4/11/2023 9:39:23 AM

MILENKO@DRAFTCODESIGNS.COM WEB: DRAFTCODESIGNS.COM

Arch D (36"x24") Drawing Size Required

0.0

0.0

0.0

DESIGNS LLC

509.251.5939

BUILDING INFO:

MAIN LEVEL 1427
SECOND LEVEL 1368
GARAGE 1213
COVERED ENTRY 264
LIVING SPACE 2795
NON-LIVING SPACE 1477
TOTAL SCOPE 4272


Job No. 22-16

OWE RESIDENCE
CUSTOM HOME
781 BICKLETON HWY

COPYRIGHT NOTICE: USE OF THESE PLANS WITHOUT EXPLICIT PERMISSION OF DRAFTCO DESIGNS LLC AND PAYMENT IS A COPYRIGHT VIOLATION WHICH MAY SUBJECT THE USER TO LIABILITY UNDER BOTH STATE AND FEDERAL LAW. THE BUILDER/OWNER IS LICENSED A ONE-TIME USE OF THESE PLANS. ALL PLANS ARE SITE SPECIFIC.

NSEC

SHEET NO.:

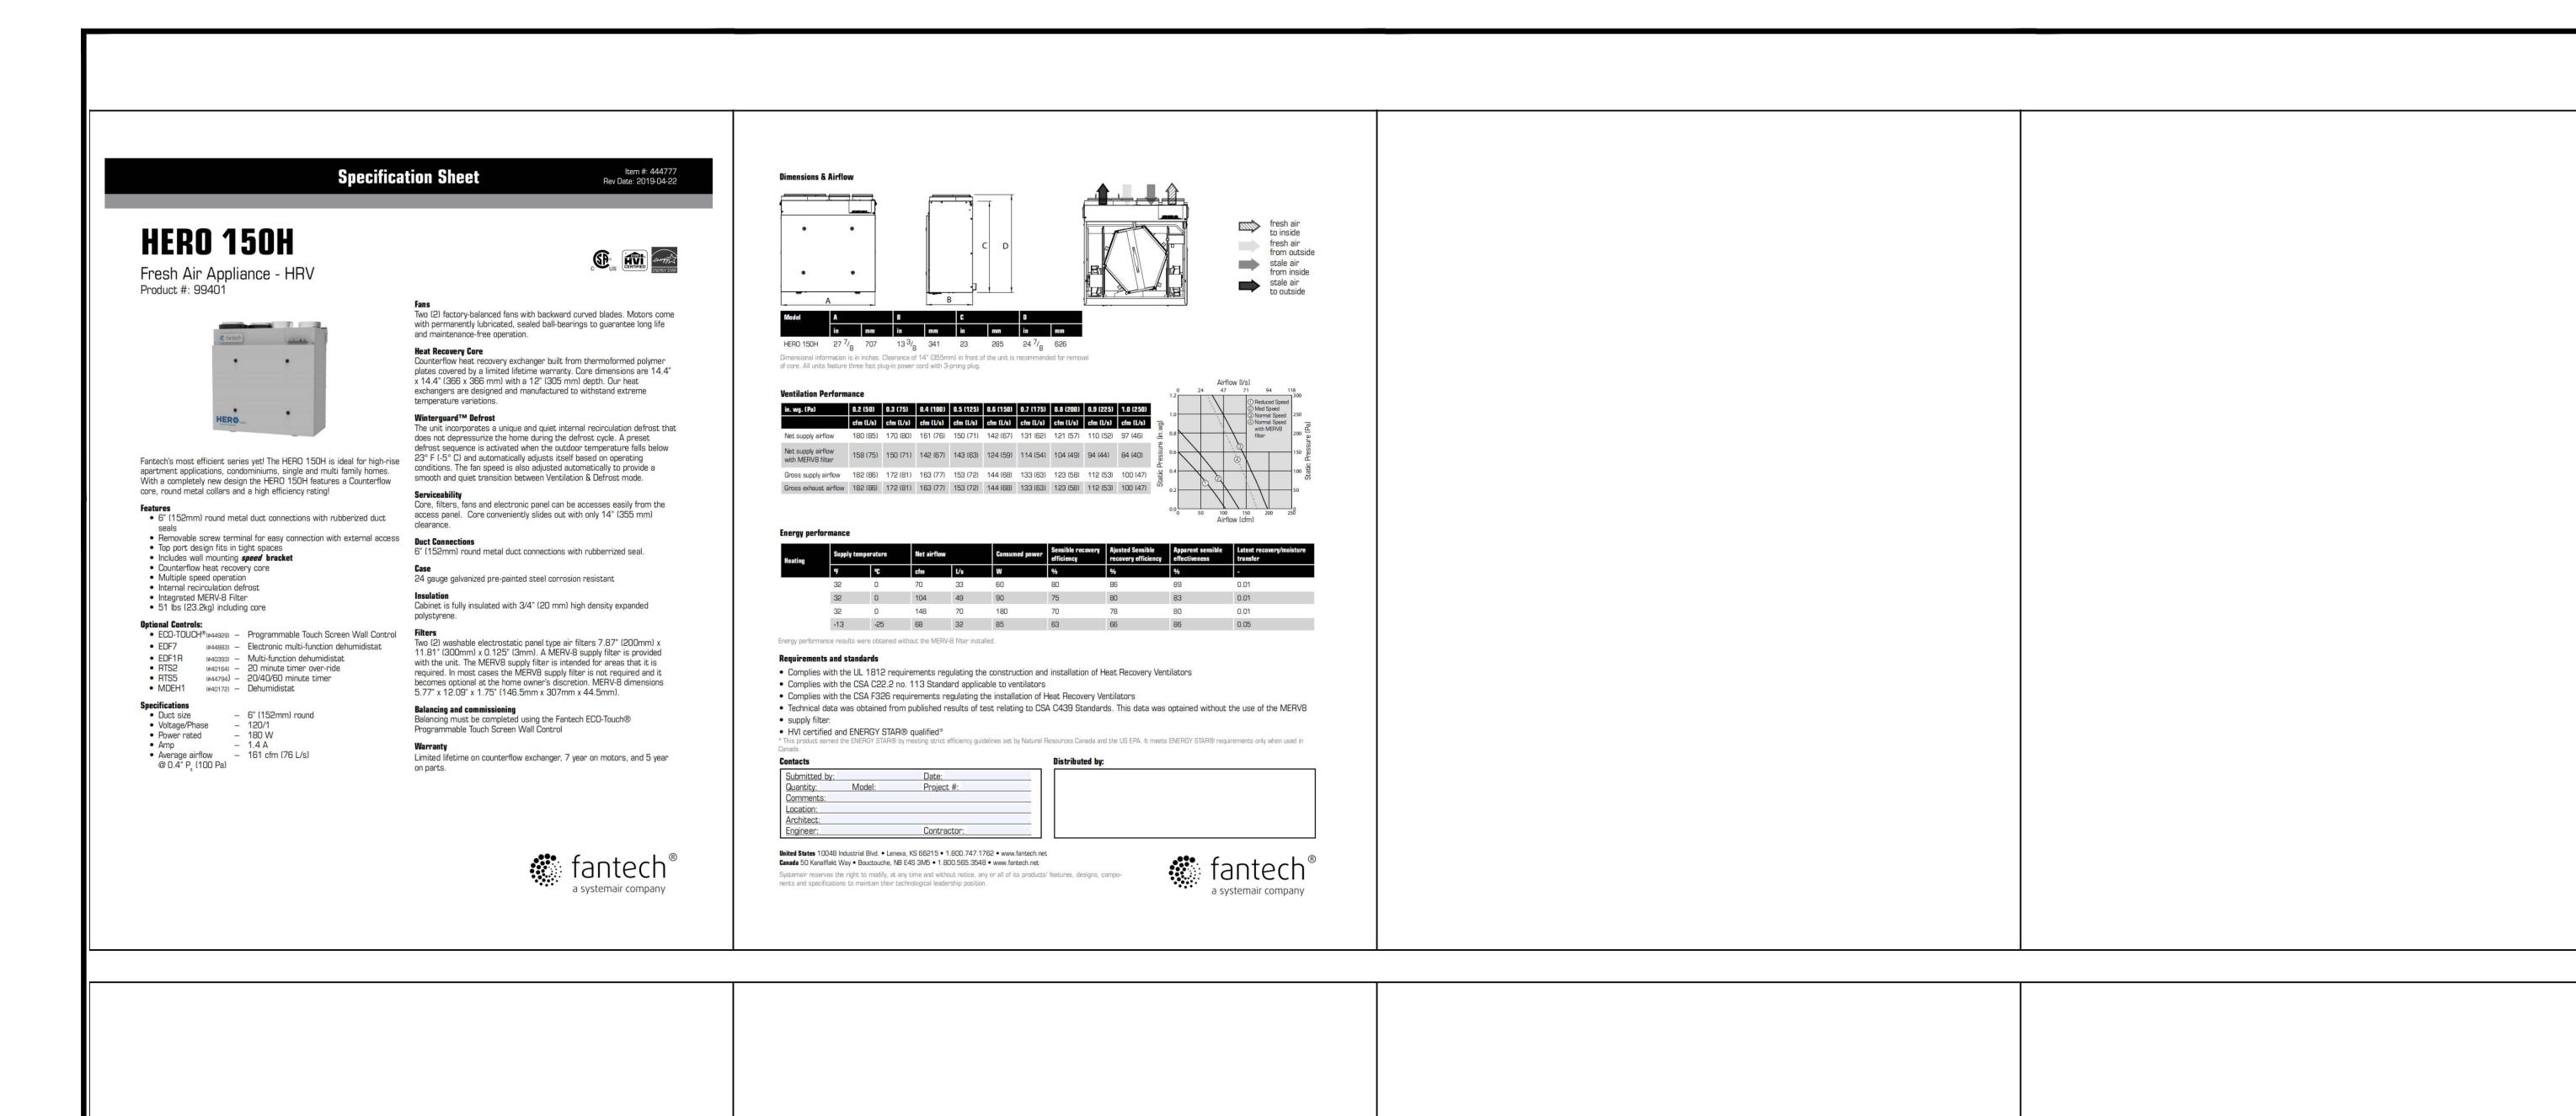

Additional Cut Sheet as Necessary

Additional Cut Sheet as Necessary

Additional Cut Sheet as Necessary

4/11/2023 9:38:50 AM

MILENKO@DRAFTCODESIGNS.COM

WEB: DRAFTCODESIGNS.COM

509.251.5939

BUILDING INFO:

1368

MAIN LEVEL

GARAGE

SECOND LEVEL

COVERED ENTRY

NON-LIVING SPACE

LIVING SPACE

TOTAL SCOPE

Additional Cut Sheet as Necessary

COPYRIGHT NOTICE: USE OF THESE
PLANS WITHOUT EXPLICIT PERMISSION
OF DRAFTCO DESIGNS LLC AND
PAYMENT IS A COPYRIGHT VIOLATION
WHICH MAY SUBJECT THE USER TO LIABILITY UNDER BOTH STATE AND FEDERAL LAW. THE BUILDER/OWNER IS LICENSED A ONE-TIME USE OF THESE PLANS. ALL PLANS ARE SITE SPECIFIC.

WSEC